

SHEPPARD & ROUT

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SOUTH BRIGHTON SURF LIFE SAVING CLUB BUILDING

269 MARINE PARADE, SOUTH BRIGHTON, CHRISTCHURCH 2283

TENDER UPDATE / CONSTRUCTION ISSUE

FEBRUARY 2019

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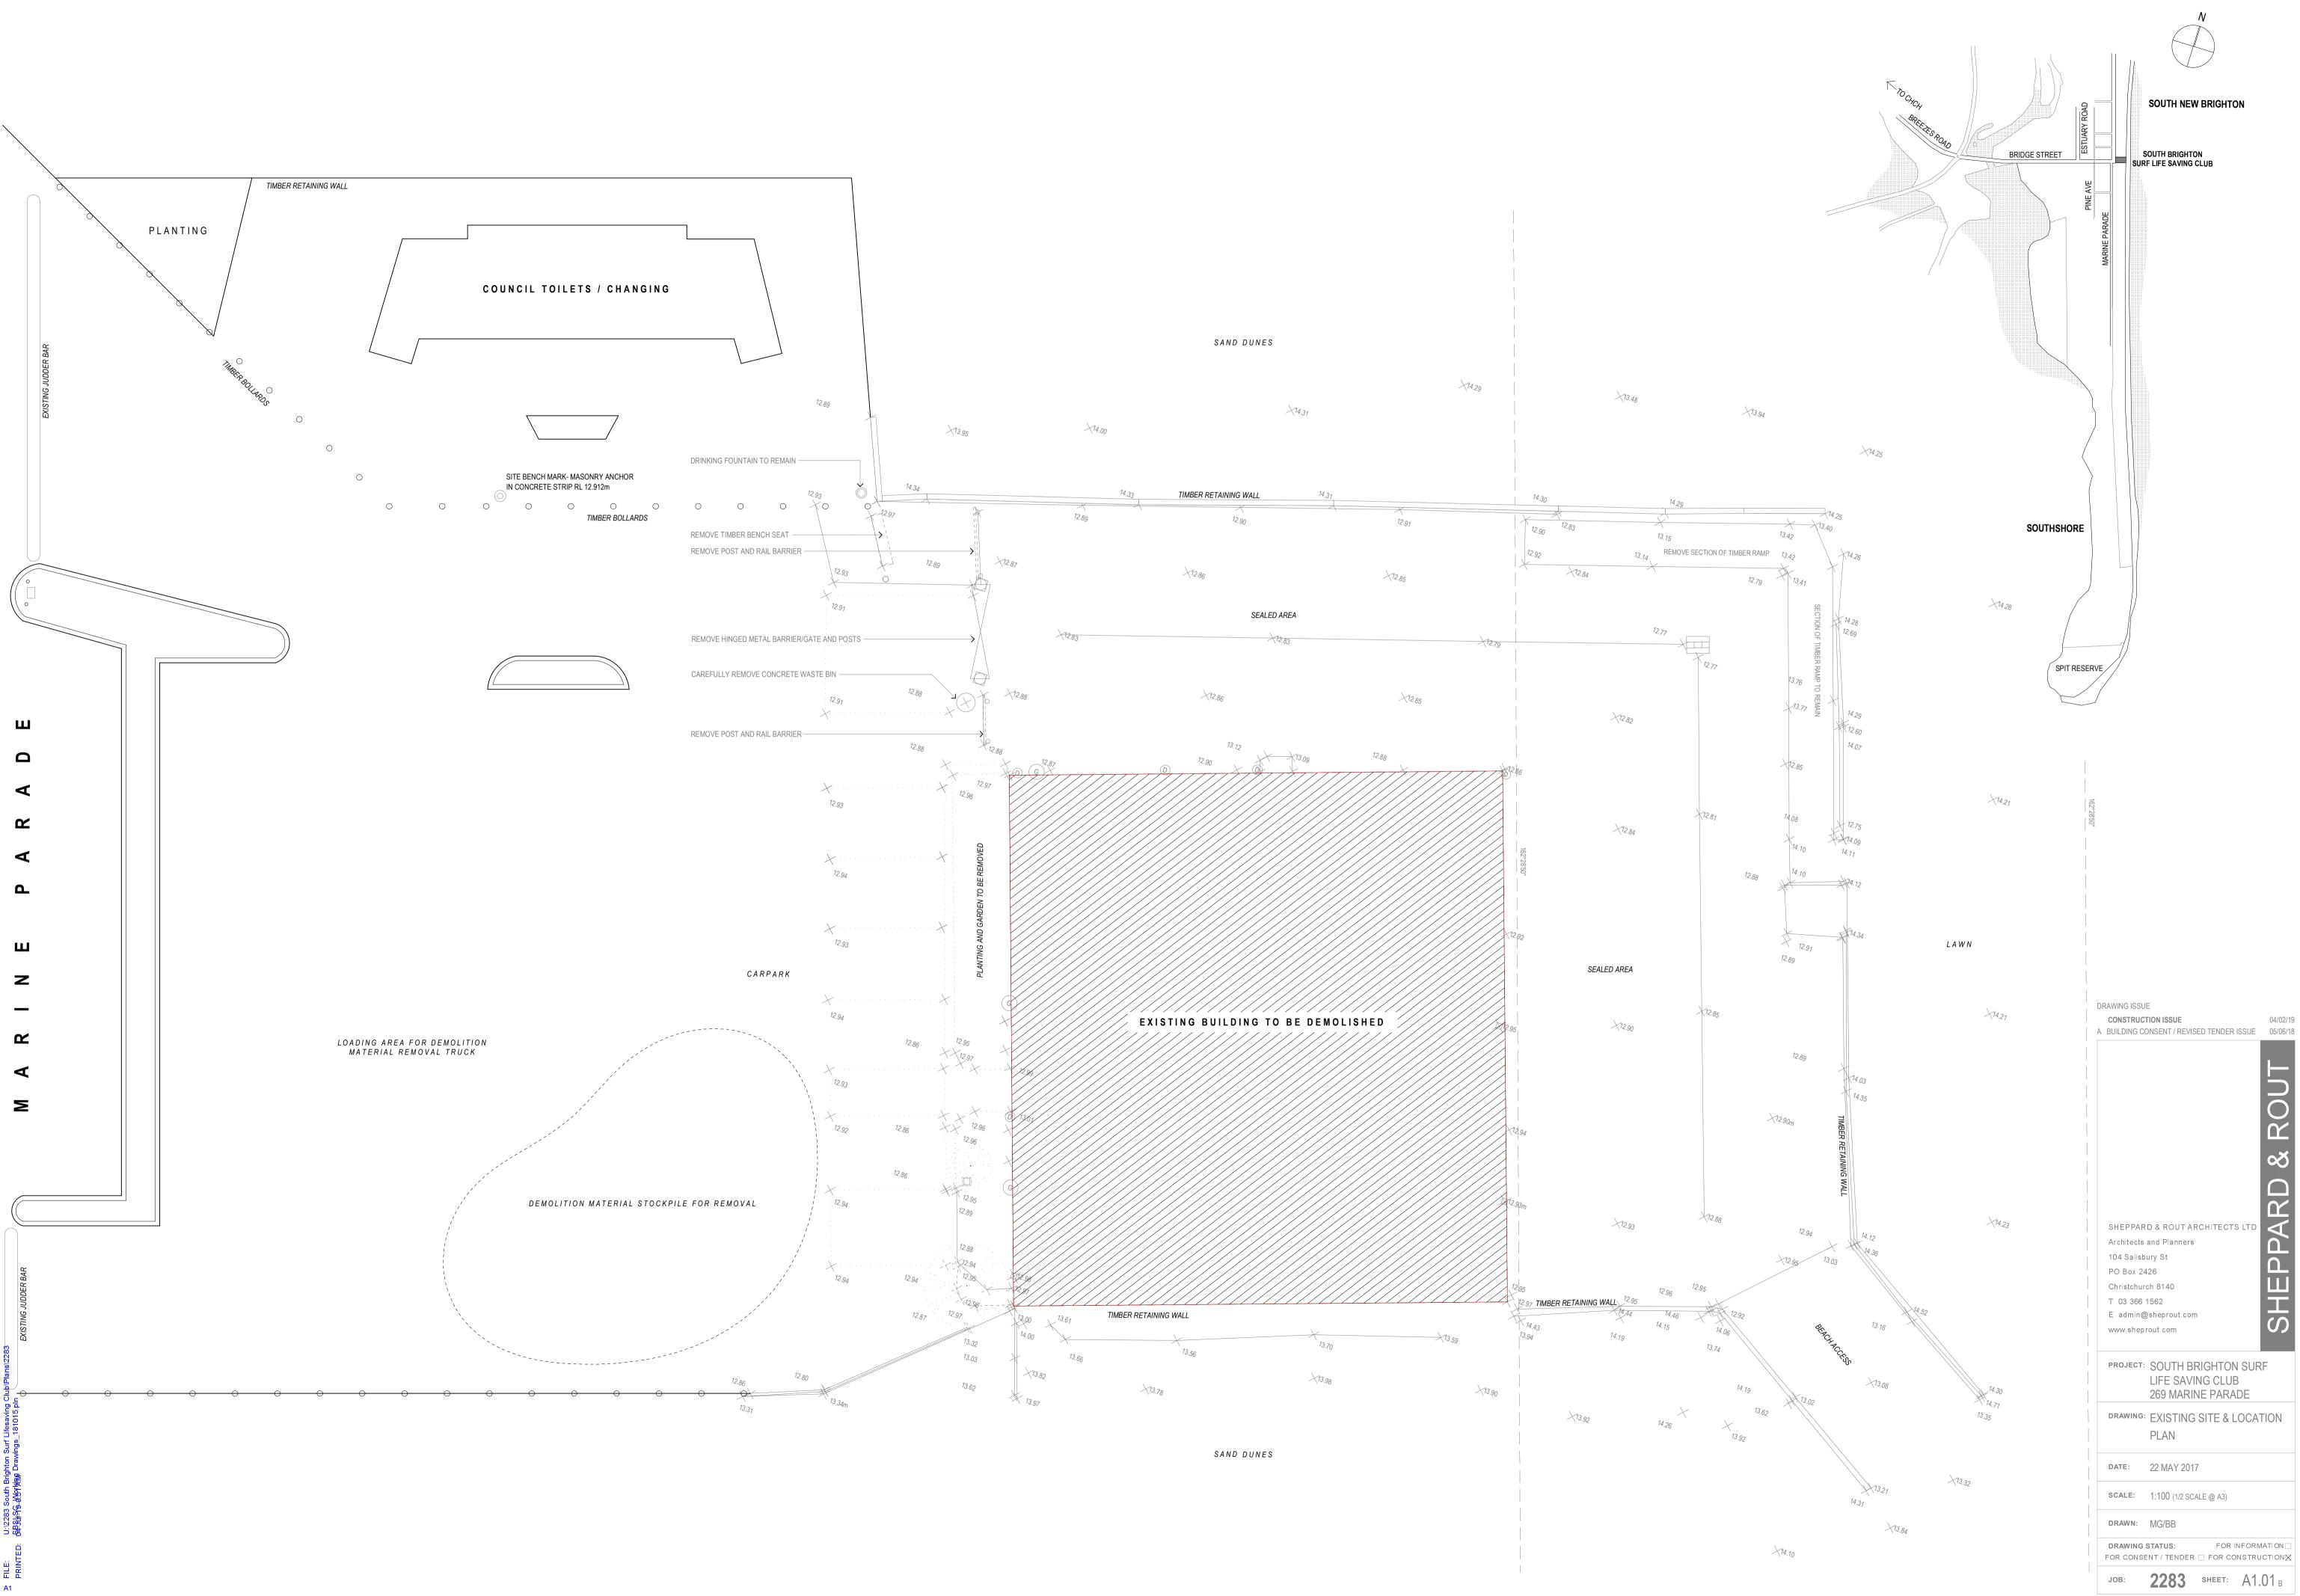
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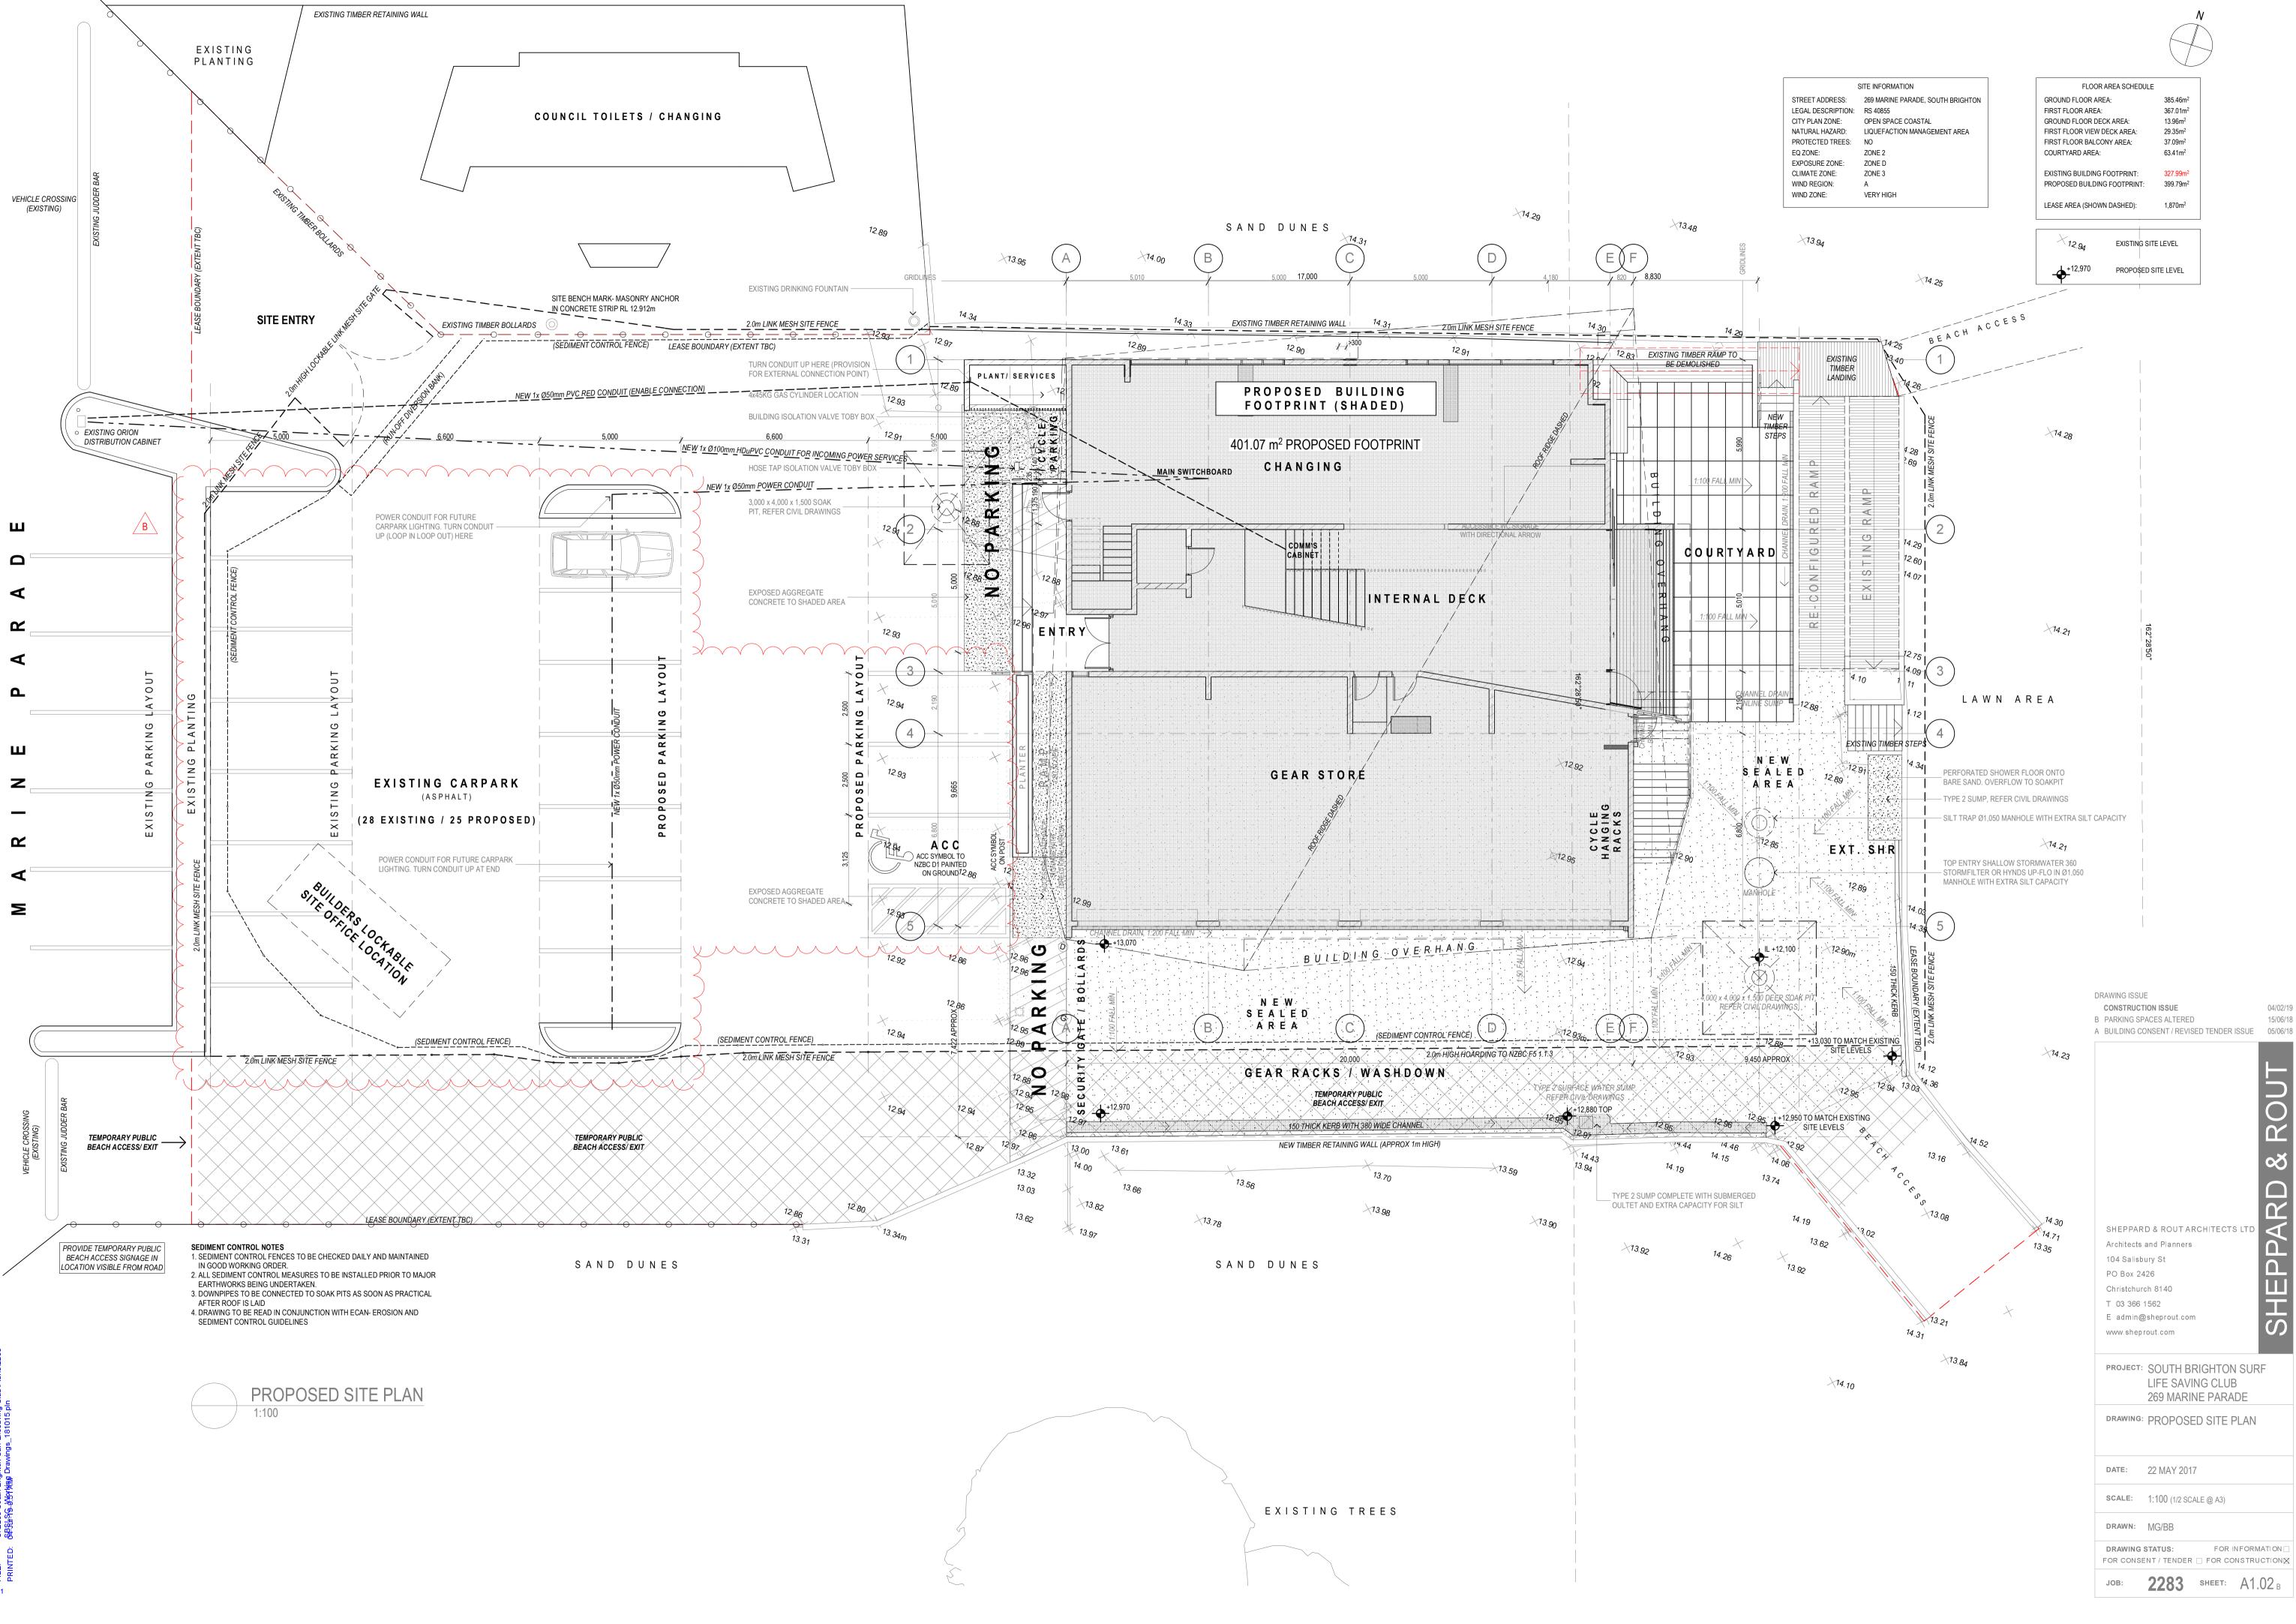
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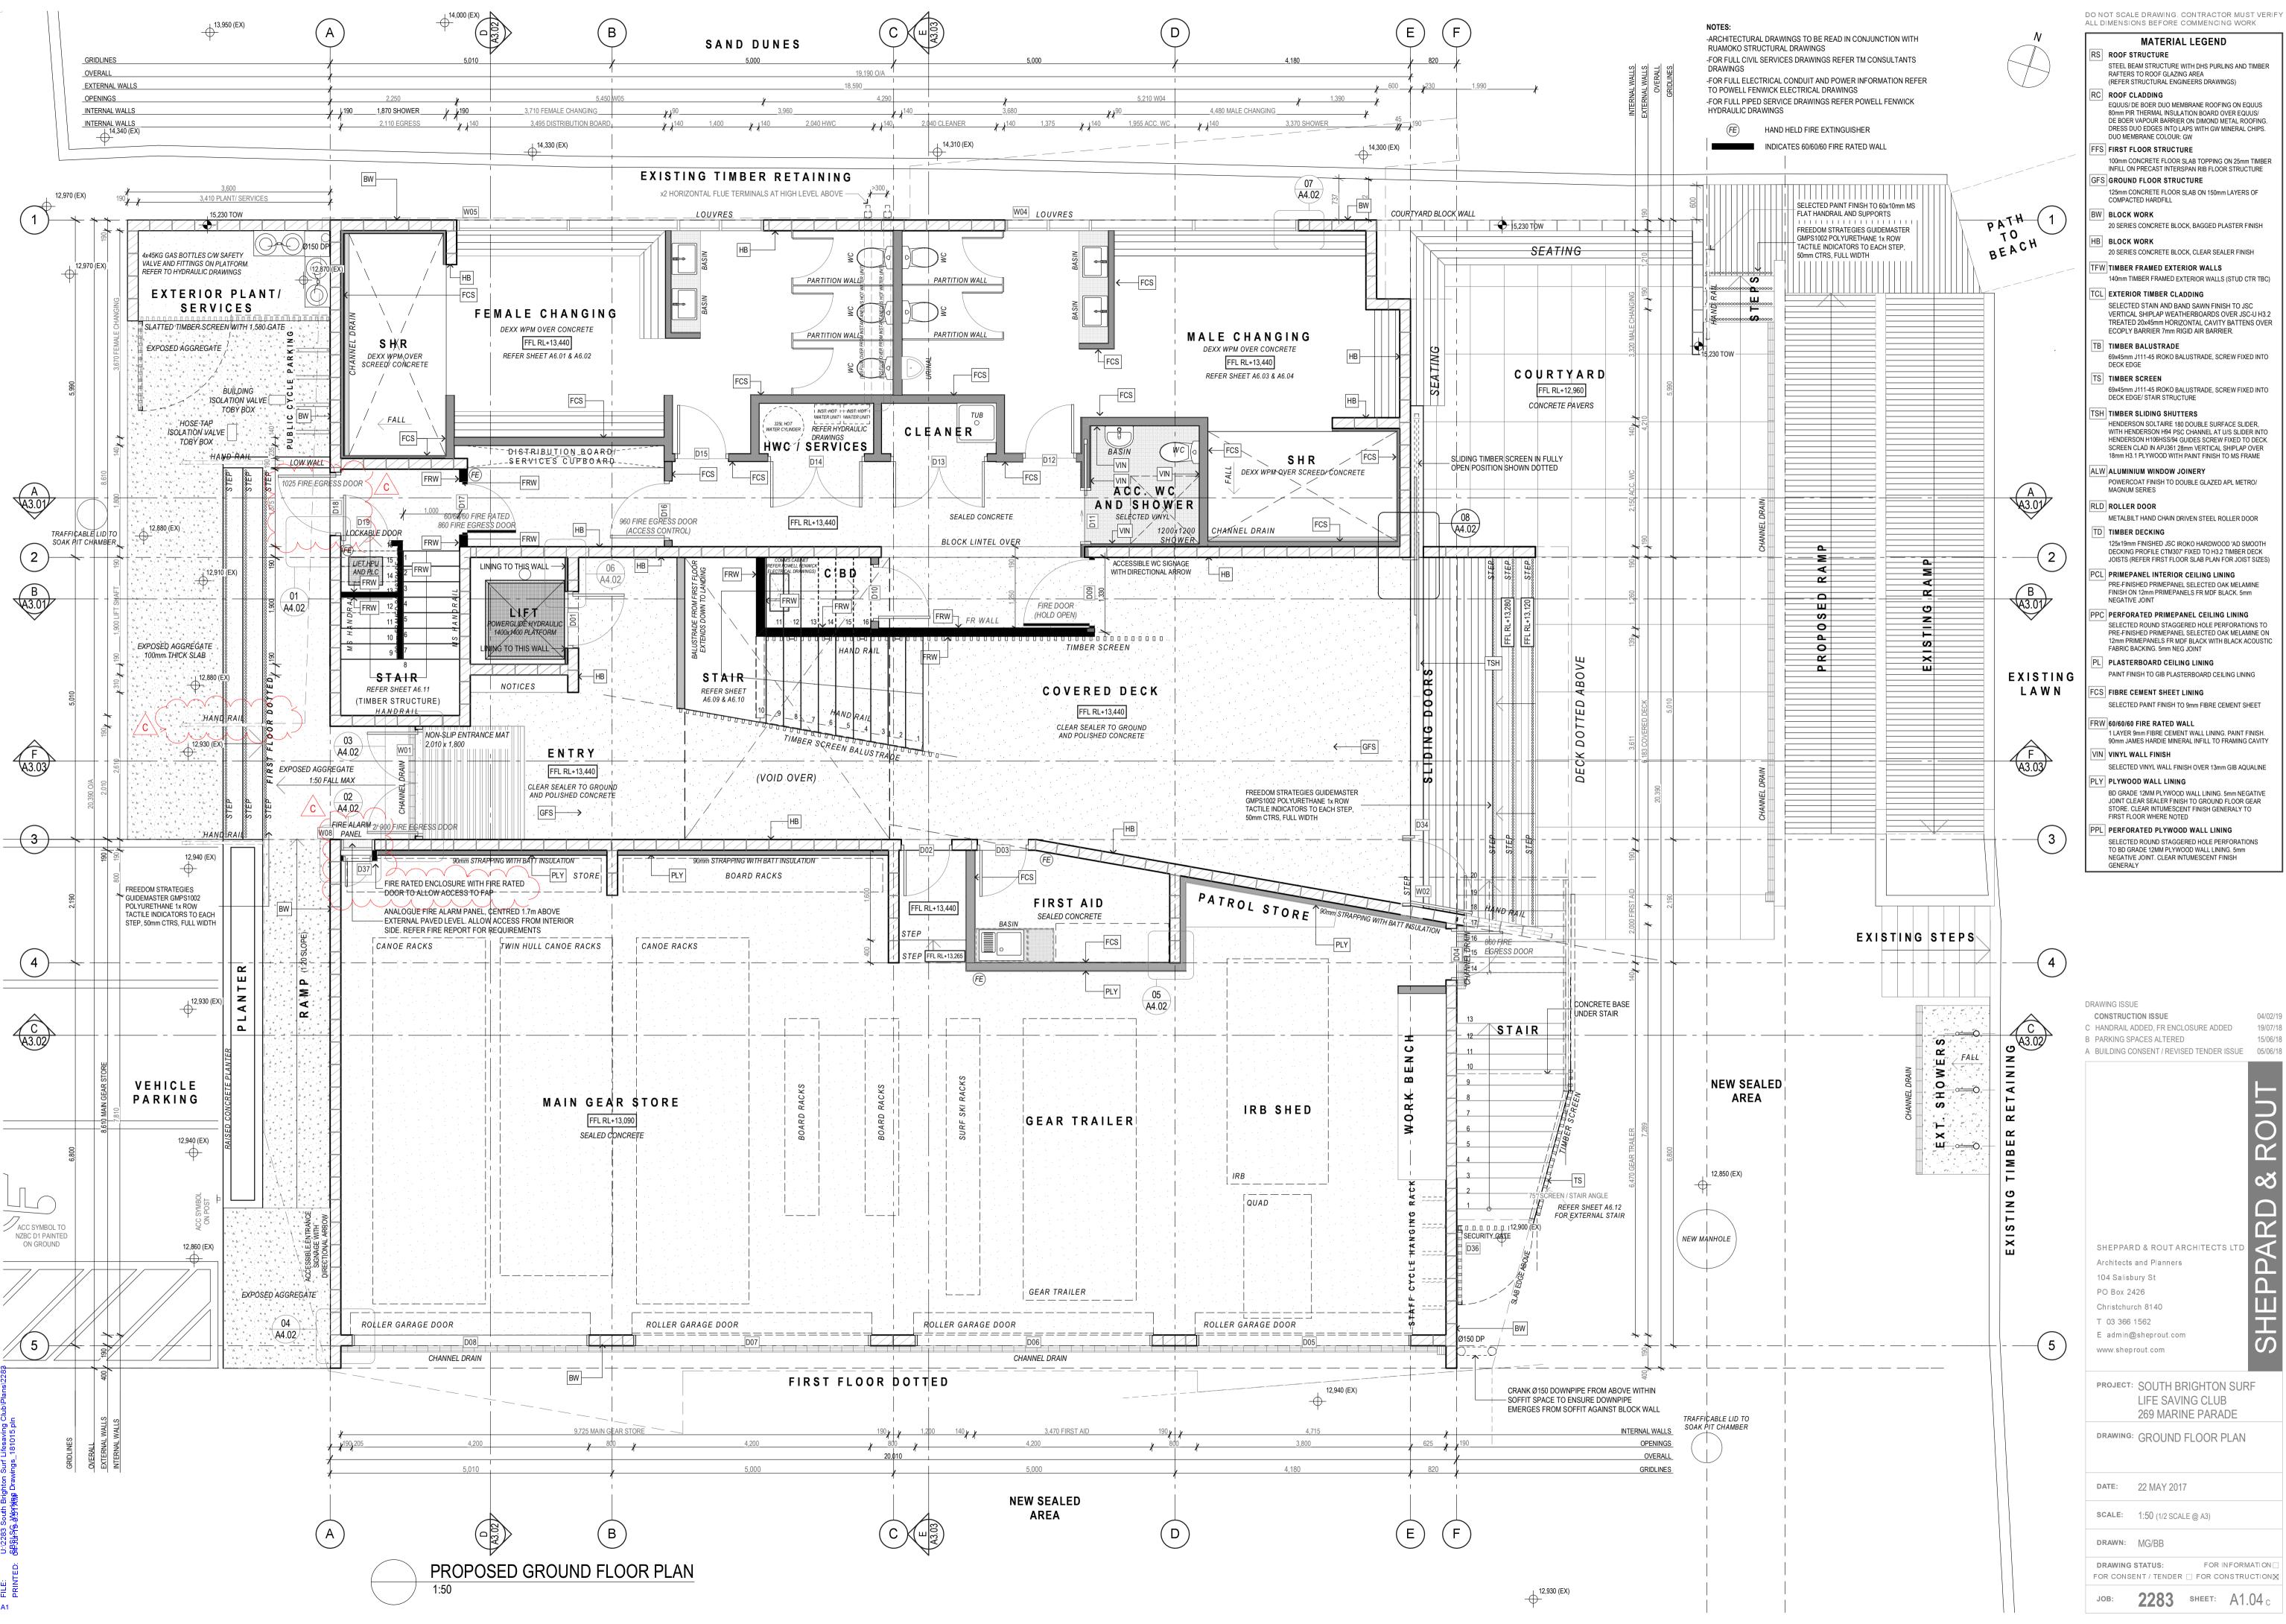






04/02/19

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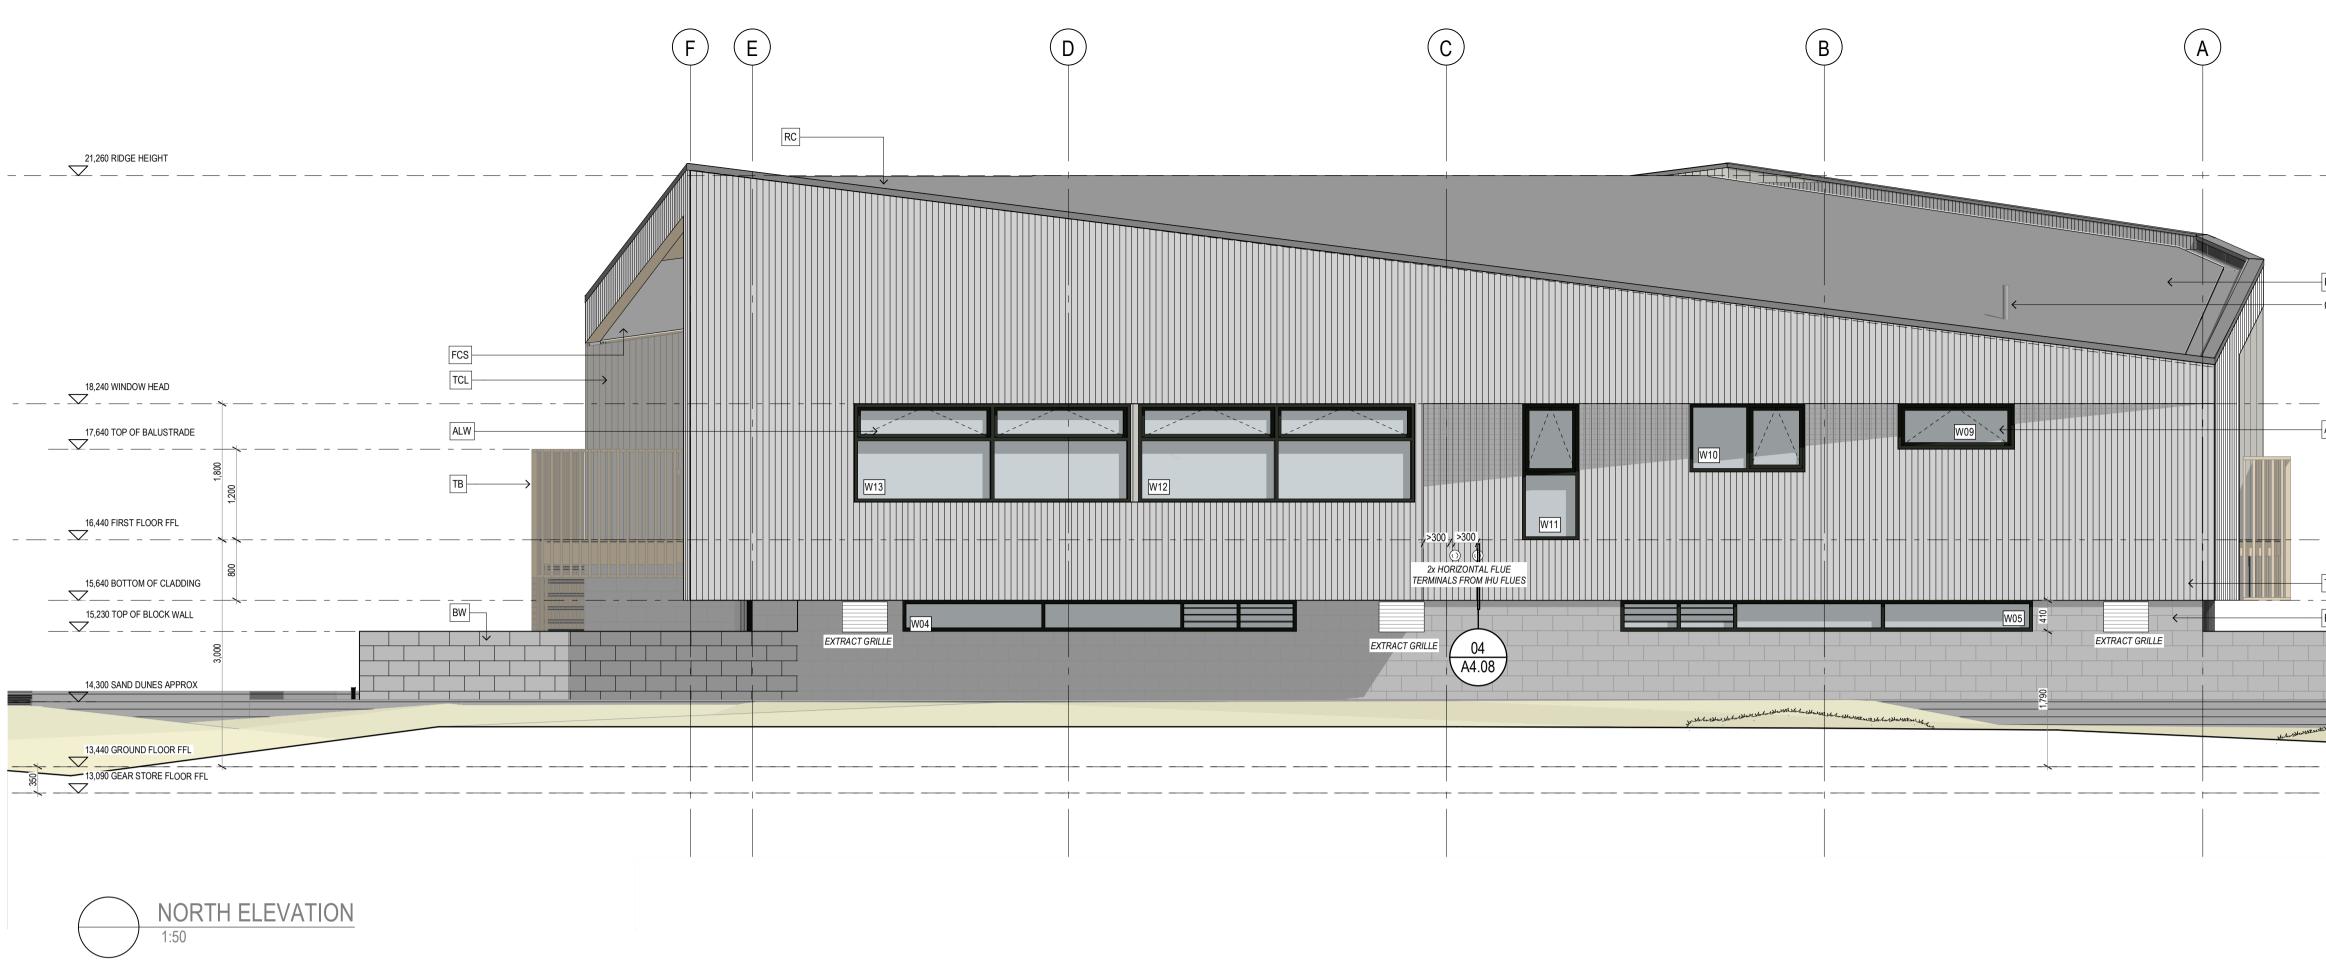




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			N	MATERIAL LEGEND RS ROOF STRUCTURE
	RAWINGS TO BE READ IN CONJUNCTION	WITH		STEEL BEAM STRUCTURE WITH DHS PURLINS AND TIMBER RAFTERS TO ROOF GLAZING AREA (REFER STRUCTURAL ENGINEERS DRAWINGS)
	JRAL DRAWINGS VICES DRAWINGS REFER TM CONSULTA	ANTS		RC ROOF CLADDING EQUUS/ DE BOER DUO MEMBRANE ROOFING ON EQUUS 80mm PIR THERMAL INSULATION BOARD OVER EQUUS/
FENWIC PED SE	CAL CONDUIT AND POWER INFORMATION IX ELECTRICAL DRAWINGS RVICE DRAWINGS REFER POWELL FENV			DE BOER VAPOUR BARRIER ON DIMOND METAL ROOFING. DRESS DUO EDGES INTO LAPS WITH GW MINERAL CHIPS. DUO MEMBRANE COLOUR: GW FFS FIRST FLOOR STRUCTURE
DRAWI				100mm CONCRETE FLOOR SLAB TOPPING ON 25mm TIMBER INFILL ON PRECAST INTERSPAN RIB FLOOR STRUCTURE
	HAND HELD FIRE EXTINGUISHER			GFS GROUND FLOOR STRUCTURE 125mm CONCRETE FLOOR SLAB ON 150mm LAYERS OF COMPACTED HARDFILL
	INDICATES 60/60/60 FIRE RATED WALL		—(1)	BW BLOCK WORK 20 SERIES CONCRETE BLOCK, BAGGED PLASTER FINISH
	SIZE TABLE- FROM NZS 3604 TABLE 8.4	DWANGS		HB BLOCK WORK
	NG FRAMING TO U/S STEEL STRUCTURE) (SPACED FOR CAVITY BATTEN REQUIREMENTS)		20 SERIES CONCRETE BLOCK, CLEAR SEALER FINISH TFW TIMBER FRAMED EXTERIOR WALLS
HT	STUD SIZE AND SPACING 140x45 SG8 @ 600 MAX CTRS	DWANG SIZE AND SPACING 140x45 SG8 @ 480 MAX CTRS	-	140mm TIMBER FRAMED EXTERIOR WALLS (STUD CTR TBC) TCL EXTERIOR TIMBER CLADDING
	140x45 SG8 @ 600 MAX CTRS 140x45 SG8 @ 600 MAX CTRS	140x45 SG8 @ 480 MAX CTRS 140x45 SG8 @ 480 MAX CTRS	_	SELECTED STAIN AND BAND SAWN FINISH TO JSC VERTICAL SHIPLAP WEATHERBOARDS OVER JSC-U H3.2 TREATED 20x45mm HORIZONTAL CAVITY BATTENS OVER
	140x45 SG8 @ 600 MAX CTRS	140x45 SG8 @ 480 MAX CTRS	_	ECOPLY BARRIER 7mm RIGID AIR BARRIER.
	140x45 SG8 @ 400 MAX CTRS 140x45 SG8 @ 400 MAX CTRS	140x45 SG8 @ 480 MAX CTRS 140x45 SG8 @ 480 MAX CTRS		69x45mm J111-45 IROKO BALUSTRADE, SCREW FIXED INTO DECK EDGE
	140x45 SG8 @ 300 MAX CTRS 140x70 SG8 @ 300 MAX CTRS	140x45 SG8 @ 480 MAX CTRS 140x45 SG8 @ 480 MAX CTRS	_	TS TIMBER SCREEN 69x45mm J111-45 IROKO BALUSTRADE, SCREW FIXED INTO
JSC V	ERTICLAD BATTEN LAYOUT DIAGRAM AN	ID INSTALLATION INSTRUCTIONS	_	DECK EDGE/ STAIR STRUCTURE TSH TIMBER SLIDING SHUTTERS
				HENDERSON SOLTAIRE 180 DOUBLE SURFACE SLIDER, WITH HENDERSON H94 PSC CHANNEL AT U/S SLIDER INTO HENDERSON H106HSS/94 GUIDES SCREW FIXED TO DECK. SCREEN CLAD IN APJ361 28mm VERTICAL SHIPLAP OVER 18mm H3.1 PLYWOOD WITH PAINT FINISH TO MS FRAME
				ALW ALUMINIUM WINDOW JOINERY POWERCOAT FINISH TO DOUBLE GLAZED APL METRO/
			A A3.01	MAGNUM SERIES
			\forall	METALBILT HAND CHAIN DRIVEN STEEL ROLLER DOOR
_			(2)	125x19mm FINISHED JSC IROKO HARDWOOD 'AD SMOOTH DECKING PROFILE CTM307' FIXED TO H3.2 TIMBER DECK
		=	2	JOISTS (REFER FIRST FLOOR SLAB PLAN FOR JOIST SIZES) PCL PRIMEPANEL INTERIOR CEILING LINING
			B A3.01	PRE-FINISHED PRIMEPANEL SELECTED OAK MELAMINE FINISH ON 12mm PRIMEPANELS FR MDF BLACK. 5mm NEGATIVE JOINT
				PPC PERFORATED PRIMEPANEL CEILING LINING SELECTED ROUND STAGGERED HOLE PERFORATIONS TO DEFINICIPAL DRIMEPANEL SELECTED OVER MELANINE ON
				PRE-FINISHED PRIMEPANEL SELECTED OAK MELAMINE ON 12mm PRIMEPANELS FR MDF BLACK WITH BLACK ACOUSTIC FABRIC BACKING. 5mm NEG JOINT
				PL PLASTERBOARD CEILING LINING PAINT FINISH TO GIB PLASTERBOARD CEILING LINING
				FCS FIBRE CEMENT SHEET LINING SELECTED PAINT FINISH TO 9mm FIBRE CEMENT SHEET
				FRW 60/60/60 FIRE RATED WALL
			$ \land $	1 LAYER 9mm FIBRE CEMENT WALL LINING. PAINT FINISH. 90mm JAMES HARDIE MINERAL INFILL TO FRAMING CAVITY
			A3.03	VIN VINYL WALL FINISH SELECTED VINYL WALL FINISH OVER 13mm GIB AQUALINE
				PLY PLYWOOD WALL LINING
				BD GRADE 12MM PLYWOOD WALL LINING. 5mm NEGATIVE
				JOINT CLEAR SEALER FINISH TO GROUND FLOOR GEAR STORE: CLEAR INTUMESCENT FINISH GENERALY TO FIRST FLOOR WHERE NOTED
			3	JOINT CLEAR SEALER FINISH TO GROUND FLOOR GEAR STORE. CLEAR INTUMESCENT FINISH GENERALY TO
			3	JOINT CLEAR SEALER FINISH TO GROUND FLOOR GEAR STORE. CLEAR INTUMESCENT FINISH GENERALY TO FIRST FLOOR WHERE NOTED PPL PERFORATED PLYWOOD WALL LINING SELECTED ROUND STAGGERED HOLE PERFORATIONS TO BD GRADE 12MM PLYWOOD WALL LINING. 5mm NEGATIVE JOINT. CLEAR INTUMESCENT FINISH
			4	JOINT CLEAR SEALER FINISH TO GROUND FLOOR GEAR STORE. CLEAR INTUMESCENT FINISH GENERALY TO FIRST FLOOR WHERE NOTED PPL PERFORATED PLYWOOD WALL LINING SELECTED ROUND STAGGERED HOLE PERFORATIONS TO BD GRADE 12MM PLYWOOD WALL LINING. 5mm NEGATIVE JOINT. CLEAR INTUMESCENT FINISH
			3	JOINT CLEAR SEALER FINISH TO GROUND FLOOR GEAR STORE. CLEAR INTUMESCENT FINISH GENERALY TO FIRST FLOOR WHERE NOTED PPL PERFORATED PLYWOOD WALL LINING SELECTED ROUND STAGGERED HOLE PERFORATIONS TO BD GRADE 12MM PLYWOOD WALL LINING. 5mm NEGATIVE JOINT. CLEAR INTUMESCENT FINISH
				DRAWING ISSUE CONSTRUCTION ISSUE B EGRESS LEAF AMENDED DIVIOUS CLEAR INTUMESCENT FINISH GENERALY TO FIRST FLOOR WHERE NOTED DIVISION CLEAR INTUMESCENT FINISH GENERALY DIVISION CLEAR INTUMESCENT FIN
				DRAWING ISSUE CONSTRUCTION ISSUE DRAWING ISSUEARAWING I IIJUT
				JOINT CLEAR SEALER FINISH TO GROUND FLOOR GEAR STORE. CLEAR INTUMESCENT FINISH GENERALY TO FIRST FLOOR WHERE NOTED PERFORATED PLYWOOD WALL LINING SELECTED ROUND STAGGERED HOLE PERFORATIONS TO BD GRADE 12MM PLYWOOD WALL LINING. 5mm NEGATIVE. JOINT. CLEAR INTUMESCENT FINISH GENERALY DRAWING ISSUE CONSTRUCTION ISSUE DRAWING CONSENT / REVISED TENDER ISSUE B EGRESS LEAF AMENDED A BUILDING CONSENT / REVISED TENDER ISSUE SHEPPARD & ROUT ARCHITECTS LTD Architects and Planners 104 Salisbury St PO Box 2426 Christchurch 8140 T 03 366 1562 E admin@sheprout.com
				JOINT CLEAR SEALER FINISH TO GROUND FLOOR GEAR STORE. CLEAR INTUMESCENT FINISH GENERALY TO FIRST FLOOR WHERE NOTED PPL PERFORATED PLYWOOD WALL LINING SELECTED ROUND STAGGERED HOLE PERFORATIONS TO BD GRADE 12MM PLYWOOD WALL LINING. 5mm NEGATIVE.JOINT. CLEAR INTUMESCENT FINISH GENERALY DRAWING ISSUE CONSTRUCTION ISSUE DRAWING CONSENT / REVISED TENDER ISSUE B EGRESS LEAF AMENDED A BUILDING CONSENT / REVISED TENDER ISSUE SHEPPARD & ROUT ARCHITECTS LTD Architects and Planners 104 Salisbury St PO Box 2426 Christchurch 8140 T 03 366 1562 E admin@sheprout.com
				JOINT CLEAR SEALER FINISH TO GROUND FLOOR GEAR STORE. CLEAR INTUMESCENT FINISH GENERALY TO FIRST FLOOR WHERE NOTED PERFORATED PLYWOOD WALL LINING SELECTED ROUND STAGGERED HOLE PERFORATIONS TO BD GRADE 12MM PLYWOOD WALL LINING. 5mm NG DE GRESS LEAF AMENDED B EGRESS LEAF AMENDED 19/07 A BUILDING CONSENT / REVISED TENDER ISSUE SHEPPARD & ROUT ARCHITECTS LTD Architects and Planners 104 Salisbury St PO Box 2426 Christchurch 8140 T 03 366 1562 E admin@sheprout.com www.sheprout.com WWW.sheprout.com
				JOINT CLEAR SEALER FINISH TO GROUND FLOOR GEAR STORE. CLEAR INTUMESCENT FINISH GENERALY TO FIRST FLOOR WHERE NOTED PERFORATED PLYWOOD WALL LINING SELECTED ROUND STAGGERED HOLE PERFORATIONS TO BEGARDE 13WH PLYWOOD WALL LINING, Smm NEGATIVE JOINT. CLEAR INTUMESCENT FINISH GENERALY DRAWING ISSUE CONSTRUCTION ISSUE CONSTRUCTION ISSUE B EGRESS LEAF AMENDED 19/07 A BUILDING CONSENT / REVISED TENDER ISSUE SHEPPARD & ROUT ARCHITECTS LTD Architects and Planners 104 Salisbury St PO Box 2426 Christchurch 8140 T 03 366 1562 E admin@sheprout.com WWW.sheprout.com WWW.sheprout.com WWW.sheprout.com
				JOINT CLEAR SEALER FINISH TO GROUND FLOOR GEAR FIRST FLOOR WHERE NOTED FIRST FLOOR WHERE NOTED PERFORATED PLYWOOD WALL LINING SUBJECTED ROUND STAGGERED HOLE PERFORATIONS TO BORADE 12M PLYWOOD WALL LINING, Smm NEGATIVE JOINT. CLEAR INTUMESCENT FINISH GENERALY DRAWING ISSUE CONSTRUCTION ISSUE DEGRESS LEAF AMENDED A BUILDING CONSENT / REVISED TENDER ISSUE SHEPPARD & ROUT ARCHITECTS LTD Architects and Planners 104 Salisbury St PO Box 2426 Christchurch 8140 T 03 366 1562 E admin@sheprout.com Www.sheprout.com PROJECT: SOUTH BRIGHTON SURF LIFE SAVING CLUB 269 MARINE PARADE DRAWING: FIRST FLOOR PLAN
				JOINT CLEAR SEALER FINISH TO GROUND FLOOR GEAR STORE. CLEAR INTURESCENT FINISH GENERALY TO FIRST FLOOR WHERE NOTED PERFORATED PLYWOOD WALL LINING SeleCTED ROUND STAGGERED HOLE PERFORATIONS TO BD GRADE 12MM PLYWOOD WALL LINING. Smm NEGATIVE JOINT. CLEAR INTUMESCENT FINISH GENERALY DRAWING ISSUE CONSTRUCTION ISSUE D EGRESS LEAF AMENDED B EGRESS LEAF AMENDED A BUILDING CONSENT / REVISED TENDER ISSUE SHEPPARD & ROUT ARCHITECTS LTD Architects and Planners 104 Salisbury St PO Box 2426 Christchurch 8140 T 03 366 1562 E admin@sheprout.com WWW.sheprout.com WWW.sheprout.com WWW.sheprout.com WWW.sheprout.com WWW.sheprout.com WWW.sheprout.com WWW.sheprout.com WWW.sheprout.com WWW.sheprout.com WWW.sheprout.com WWW.sheprout.com
				JOINT CLEAR SEALER FINISH TO GROUND FLOOR GEAR STORE. CLEAR INTURESCENT FINISH GENERALY TO FIRST FLOOR WHERE NOTED PERFORATED PLYWOOD WALL LINING SUB GRADE 12MM PLYWOOD WALL LINING. Smm NEGATIVE JOINT. CLEAR INTUMESCENT FINISH GENERALY DRAWING ISSUE CONSTRUCTION ISSUE D EGRESS LEAF AMENDED B EGRESS LEAF AMENDED B UILDING CONSENT / REVISED TENDER ISSUE DIAL SALISSUE CONSTRUCTION ISSUE D EGRESS LEAF AMENDED B UILDING CONSENT / REVISED TENDER ISSUE D EGRESS LEAF AMENDED SHEPPARD & ROUT ARCHITECTS LTD Architects and Planners 104 Salisbury St PO B ox 2426 Christchurch 8140 T 03 366 1562 E admin@sheprout.com WWW.sheprout.com WWW.sheprout.com DRAWING: FIRST FLOOR PLAN DRAWING: FIRST FLOOR PLAN DATE: 22 MAY 2017 SCALE: 1:50 (1/2 SCALE @ A3)







(REFER STRUCTURAL ENGINEERS DRAWINGS) ROOF CLADDING EQUUS/ DE BOER DUO MEMBRANE ROOFING ON EQUUS 80mm PIR THERMAL INSULATION BOARD OVER EQUUS/ DE BOER VAPOUR BARRIER ON DIMOND METAL ROOFING. DRESS DUO EDGES INTO LAPS WITH GW MINERAL CHIPS. 21,260 RIDGE HEIGHT DUO MEMBRANE COLOUR: GW _____ FFS FIRST FLOOR STRUCTURE 100mm CONCRETE FLOOR SLAB TOPPING ON 25mm TIMBER INFILL ON PRECAST INTERSPAN RIB FLOOR STRUCTURE GFS GROUND FLOOR STRUCTURE 125mm CONCRETE FLOOR SLAB ON 150mm LAYERS OF COMPACTED HARDFILL BW BLOCK WORK 20 SERIES CONCRETE BLOCK, BAGGED PLASTER FINISH RC HB BLOCK WORK - Ø80 STACK VENT 20 SERIES CONCRETE BLOCK, CLEAR SEALER FINISH TFW TIMBER FRAMED EXTERIOR WALLS 140mm TIMBER FRAMED EXTERIOR WALLS (STUD CTR TBC) TCL EXTERIOR TIMBER CLADDING 18,240 WINDOW HEAD/ BOTTOM OF CLADDING SELECTED STAIN AND BAND SAWN FINISH TO JSC VERTICAL SHIPLAP WEATHERBOARDS OVER JSC-U H3.2 TREATED 20x45mm HORIZONTAL CAVITY BATTENS OVER \bigtriangledown _ __ _ _ ECOPLY BARRIER 7mm RIGID AIR BARRIER. ALW TB TIMBER BALUSTRADE 69x45mm J111-45 IROKO BALUSTRADE, SCREW FIXED INTO DECK EDGE S TIMBER SCREEN 69x45mm J111-45 IROKO BALUSTRADE, SCREW FIXED INTO DECK EDGE/ STAIR STRUCTURE 16,440 FIRST FLOOR FFL SH TIMBER SLIDING SHUTTERS _ ____ \sim HENDERSON SOLTAIRE 180 DOUBLE SURFACE SLIDER, WITH HENDERSON H94 PSC CHANNEL AT U/S SLIDER INTO HENDERSON H106HSS/94 GUIDES SCREW FIXED TO DECK. SCREEN CLAD IN APJ361 28mm VERTICAL SHIPLAP OVER TCL 15,640 BOTTOM OF CLADDING 18mm H3.1 PLYWOOD WITH PAINT FINISH TO MS FRAME _____ _____ ALW ALUMINIUM WINDOW JOINERY 15,230 TOP OF BLOCK WALL BW POWERCOAT FINISH TO DOUBLE GLAZED APL METRO/ MAGNUM SERIES RLD ROLLER DOOR METALBILT HAND CHAIN DRIVEN STEEL ROLLER DOOR D TIMBER DECKING 125x19mm FINISHED JSC IROKO HARDWOOD 'AD SMOOTH DECKING PROFILE CTM307' FIXED TO H3.2 TIMBER DECK JOISTS (REFER FIRST FLOOR SLAB PLAN FOR JOIST SIZES) L PRIMEPANEL INTERIOR CEILING LINING 3,440 GROUND FLOOR FFL PRE-FINISHED PRIMEPANEL SELECTED OAK MELAMINE $\square \nabla$ FINISH ON 12mm PRIMEPANELS FR MDF BLACK. 5mm NEGATIVE JOINT 13,090 GEAR STORE FLOOR FFL ∇ ____ PPC PERFORATED PRIMEPANEL CEILING LINING SELECTED ROUND STAGGERED HOLE PERFORATIONS TO PRE-FINISHED PRIMEPANEL SELECTED OAK MELAMINE ON 12mm PRIMEPANELS FR MDF BLACK WITH BLACK ACOUSTIC FABRIC BACKING. 5mm NEG JOINT PL PLASTERBOARD CEILING LINING PAINT FINISH TO GIB PLASTERBOARD CEILING LINING FCS FIBRE CEMENT SHEET LINING SELECTED PAINT FINISH TO 9mm FIBRE CEMENT SHEET FRW 60/60/60 FIRE RATED WALL 1 LAYER 9mm FIBRE CEMENT WALL LINING. PAINT FINISH. 90mm JAMES HARDIE MINERAL INFILL TO FRAMING CAVITY VIN VINYL WALL FINISH SELECTED VINYL WALL FINISH OVER 13mm GIB AQUALINE PLY PLYWOOD WALL LINING BD GRADE 12MM PLYWOOD WALL LINING. 5mm NEGATIVE JOINT CLEAR SEALER FINISH TO GROUND FLOOR GEAR STORE. CLEAR INTUMESCENT FINISH GENERALY TO FIRST FLOOR WHERE NOTED PPL PERFORATED PLYWOOD WALL LINING SELECTED ROUND STAGGERED HOLE PERFORATIONS TO BD GRADE 12MM PLYWOOD WALL LINING. 5mm NEGATIVE JOINT. CLEAR INTUMESCENT FINISH GENERALY DRAWING ISSUE CONSTRUCTION ISSUE 04/02/19 A BUILDING CONSENT / REVISED TENDER ISSUE 05/06/18 $\overline{\bigcirc}$ **M** 16,440 FIRST FLOOR FFL \square 15,940 BOTTOM OF BALUSTRADE Ŷ SHEPPARD & ROUT ARCHITECTS LT 15,230 TOP OF BLOCK WALL PP/ Architects and Planners 104 Salisbury St PO Box 2426 ш 14,330 TOP OF RETAINING WALL Christchurch 8140 SH T 03 366 1562 E admin@sheprout.com 13,440 GROUND FLOOR FFL www.sheprout.com _____ 12,965 BOTTOM OF BLOCK **PROJECT:** SOUTH BRIGHTON SURF _____ LIFE SAVING CLUB 269 MARINE PARADE drawing: ELEVATIONS - NORTH & EAST DATE: 22 MAY 2017 **SCALE:** 1:50 (1/2 SCALE @ A3)

drawn: MG/BB

DRAWING STATUS:

FOR INFORMATION

FOR CONSENT / TENDER 🗌 FOR CONSTRUCTION🛛

JOB: **2283** SHEET: A2.01 A

DO NOT SCALE DRAWING. CONTRACTOR MUST VERIFY ALL DIMENSIONS BEFORE COMMENCING WORK

MATERIAL LEGEND

STEEL BEAM STRUCTURE WITH DHS PURLINS AND TIMBER

RS ROOF STRUCTURE

RAFTERS TO ROOF GLAZING AREA





20 SERIES CONCRETE BLOCK, BAGGED PLASTER FINISH 20 SERIES CONCRETE BLOCK, CLEAR SEALER FINISH TFW TIMBER FRAMED EXTERIOR WALLS 140mm TIMBER FRAMED EXTERIOR WALLS (STUD CTR TBC) ICL EXTERIOR TIMBER CLADDING SELECTED STAIN AND BAND SAWN FINISH TO JSC VERTICAL SHIPLAP WEATHERBOARDS OVER JSC-U H3.2 TREATED 20x45mm HORIZONTAL CAVITY BATTENS OVER ECOPLY BARRIER 7mm RIGID AIR BARRIER. 69x45mm J111-45 IROKO BALUSTRADE, SCREW FIXED INTO 69x45mm J111-45 IROKO BALUSTRADE, SCREW FIXED INTO DECK EDGE/ STAIR STRUCTURE SH TIMBER SLIDING SHUTTERS HENDERSON SOLTAIRE 180 DOUBLE SURFACE SLIDER, WITH HENDERSON H94 PSC CHANNEL AT U/S SLIDER INTO HENDERSON H106HSS/94 GUIDES SCREW FIXED TO DECK. SCREEN CLAD IN APJ361 28mm VERTICAL SHIPLAP OVER 18mm H3.1 PLYWOOD WITH PAINT FINISH TO MS FRAME ALW ALUMINIUM WINDOW JOINERY POWERCOAT FINISH TO DOUBLE GLAZED APL METRO/ METALBILT HAND CHAIN DRIVEN STEEL ROLLER DOOR 125x19mm FINISHED JSC IROKO HARDWOOD 'AD SMOOTH DECKING PROFILE CTM307' FIXED TO H3.2 TIMBER DECK JOISTS (REFER FIRST FLOOR SLAB PLAN FOR JOIST SIZES) L PRIMEPANEL INTERIOR CEILING LINING PRE-FINISHED PRIMEPANEL SELECTED OAK MELAMINE FINISH ON 12mm PRIMEPANELS FR MDF BLACK. 5mm NEGATIVE JOINT PPC PERFORATED PRIMEPANEL CEILING LINING SELECTED ROUND STAGGERED HOLE PERFORATIONS TO PRE-FINISHED PRIMEPANEL SELECTED OAK MELAMINE ON 12mm PRIMEPANELS FR MDF BLACK WITH BLACK ACOUSTIC FABRIC BACKING. 5mm NEG JOINT PL PLASTERBOARD CEILING LINING PAINT FINISH TO GIB PLASTERBOARD CEILING LINING FCS FIBRE CEMENT SHEET LINING SELECTED PAINT FINISH TO 9mm FIBRE CEMENT SHEET FRW 60/60/60 FIRE RATED WALL 1 LAYER 9mm FIBRE CEMENT WALL LINING. PAINT FINISH. 90mm JAMES HARDIE MINERAL INFILL TO FRAMING CAVITY SELECTED VINYL WALL FINISH OVER 13mm GIB AQUALINE BD GRADE 12MM PLYWOOD WALL LINING. 5mm NEGATIVE JOINT CLEAR SEALER FINISH TO GROUND FLOOR GEAR STORE. CLEAR INTUMESCENT FINISH GENERALY TO PPL PERFORATED PLYWOOD WALL LINING SELECTED ROUND STAGGERED HOLE PERFORATIONS TO BD GRADE 12MM PLYWOOD WALL LINING. 5mm NEGATIVE JOINT. CLEAR INTUMESCENT FINISH 04/02/19 19/07/18 A BUILDING CONSENT / REVISED TENDER ISSUE 05/06/18 \mathbf{M} SHEPPARD & ROUT ARCHITECTS LT DD D Ш SH PROJECT: SOUTH BRIGHTON SURF


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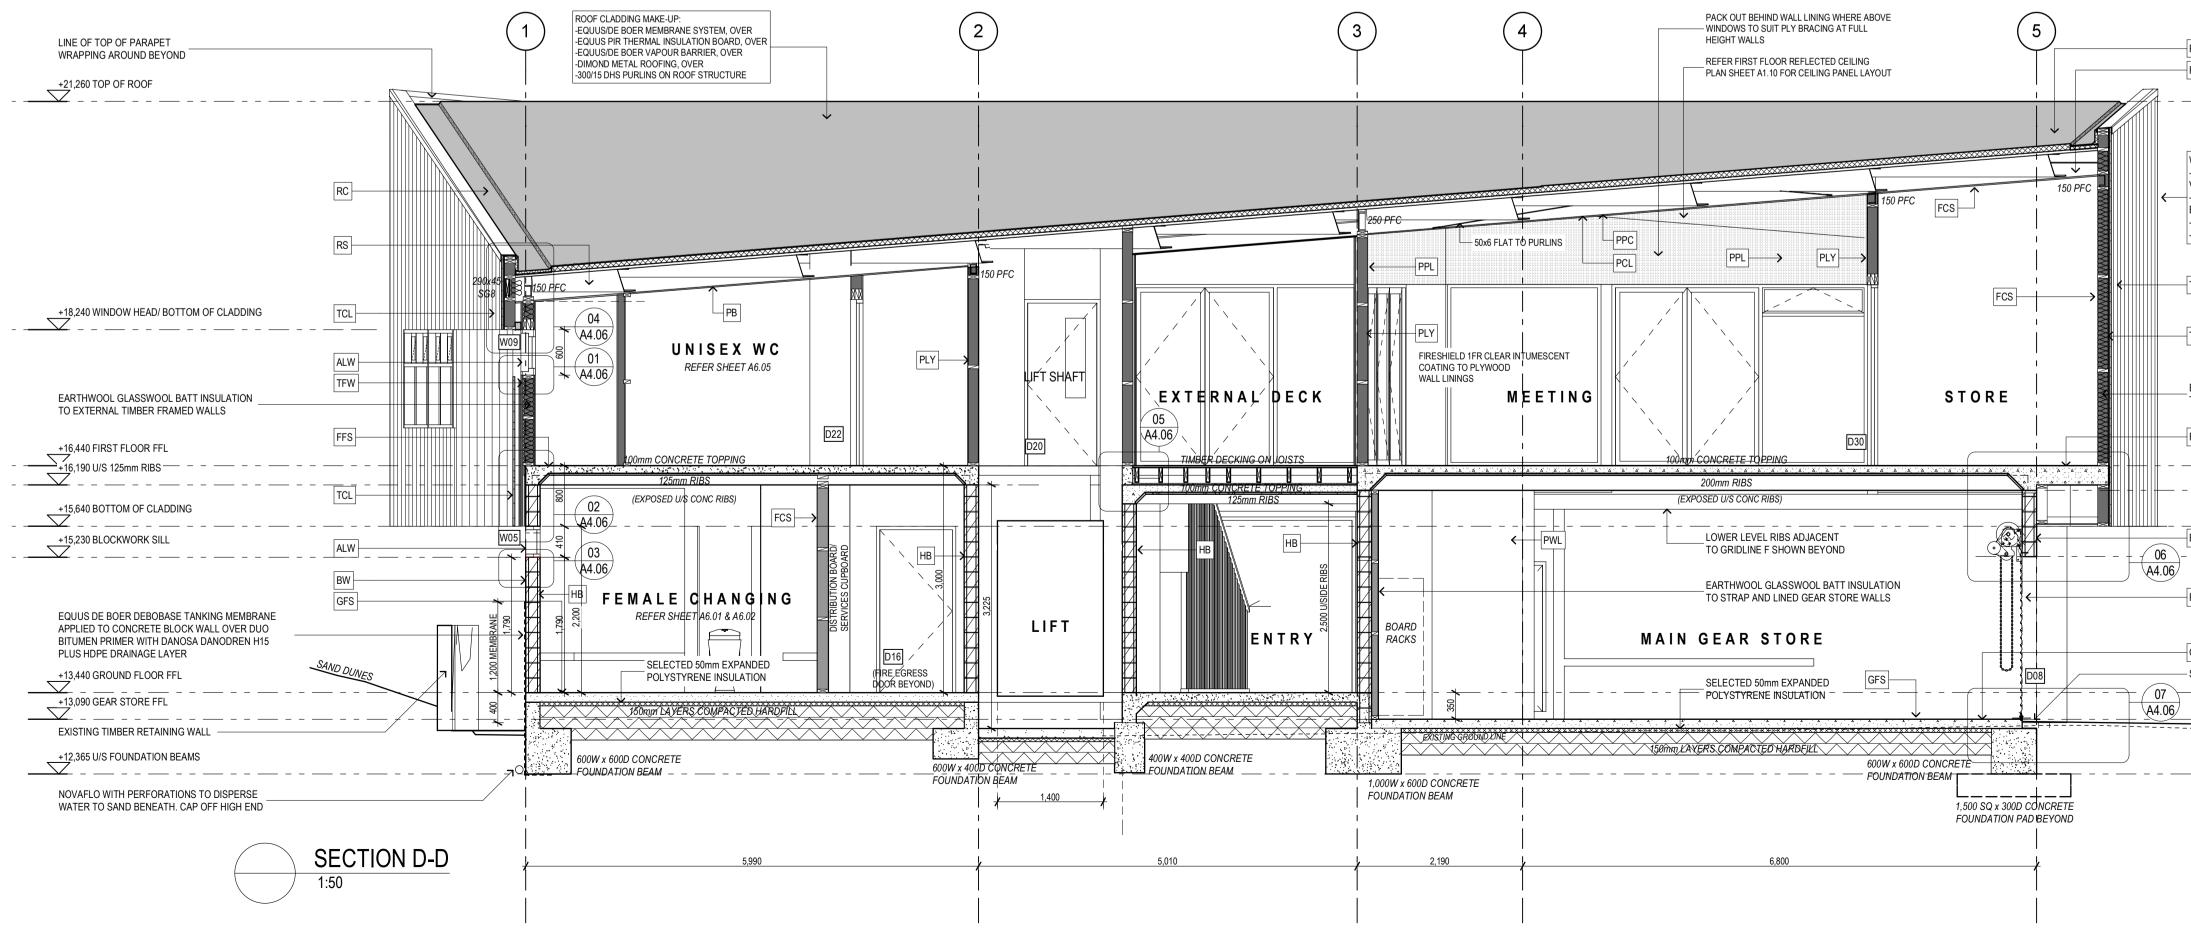
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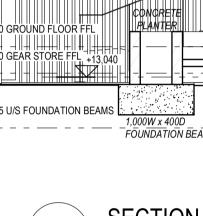
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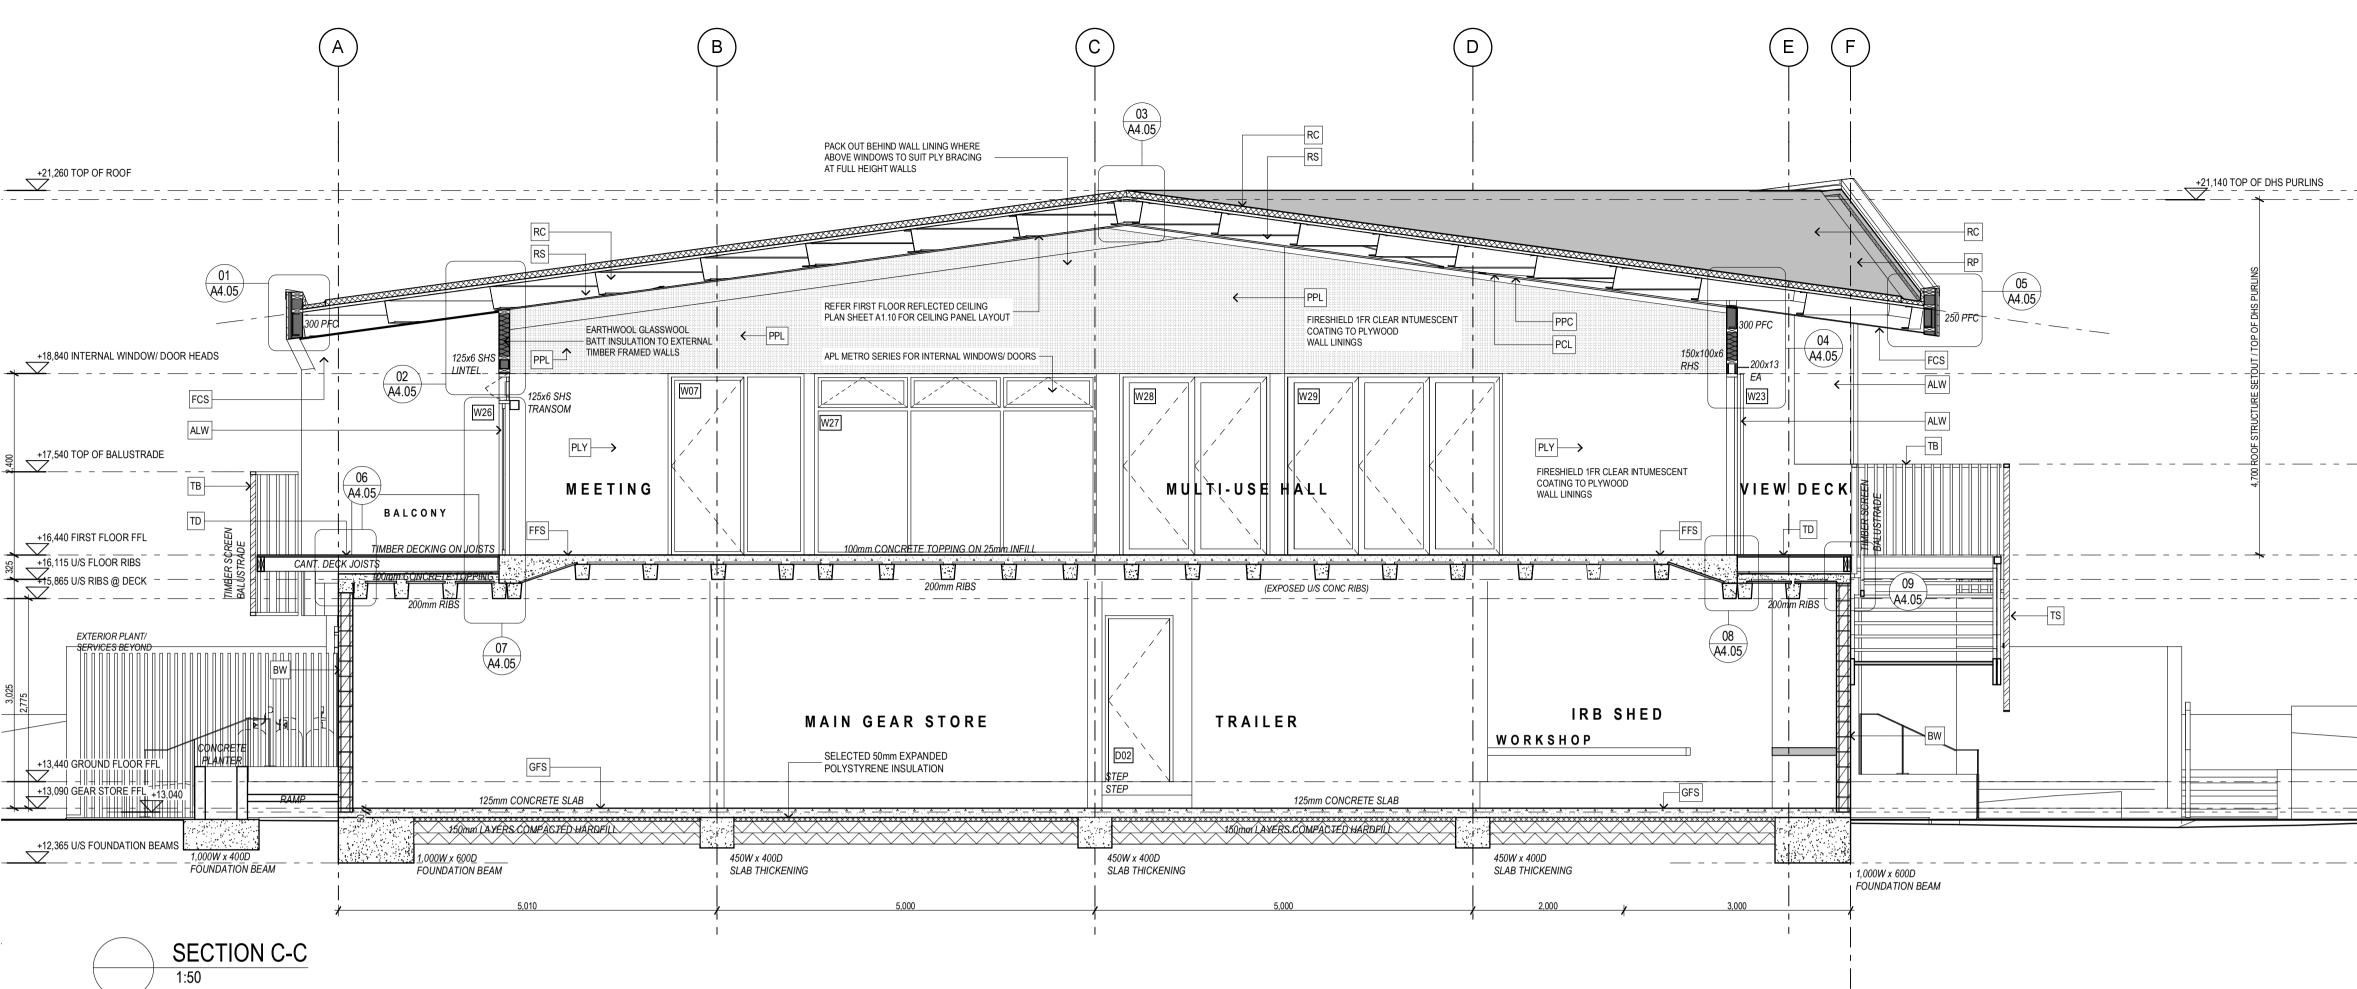
FOR CONSENT / TENDER 🗌 FOR CONSTRUCTION

2283 SHEET: A2.02 B







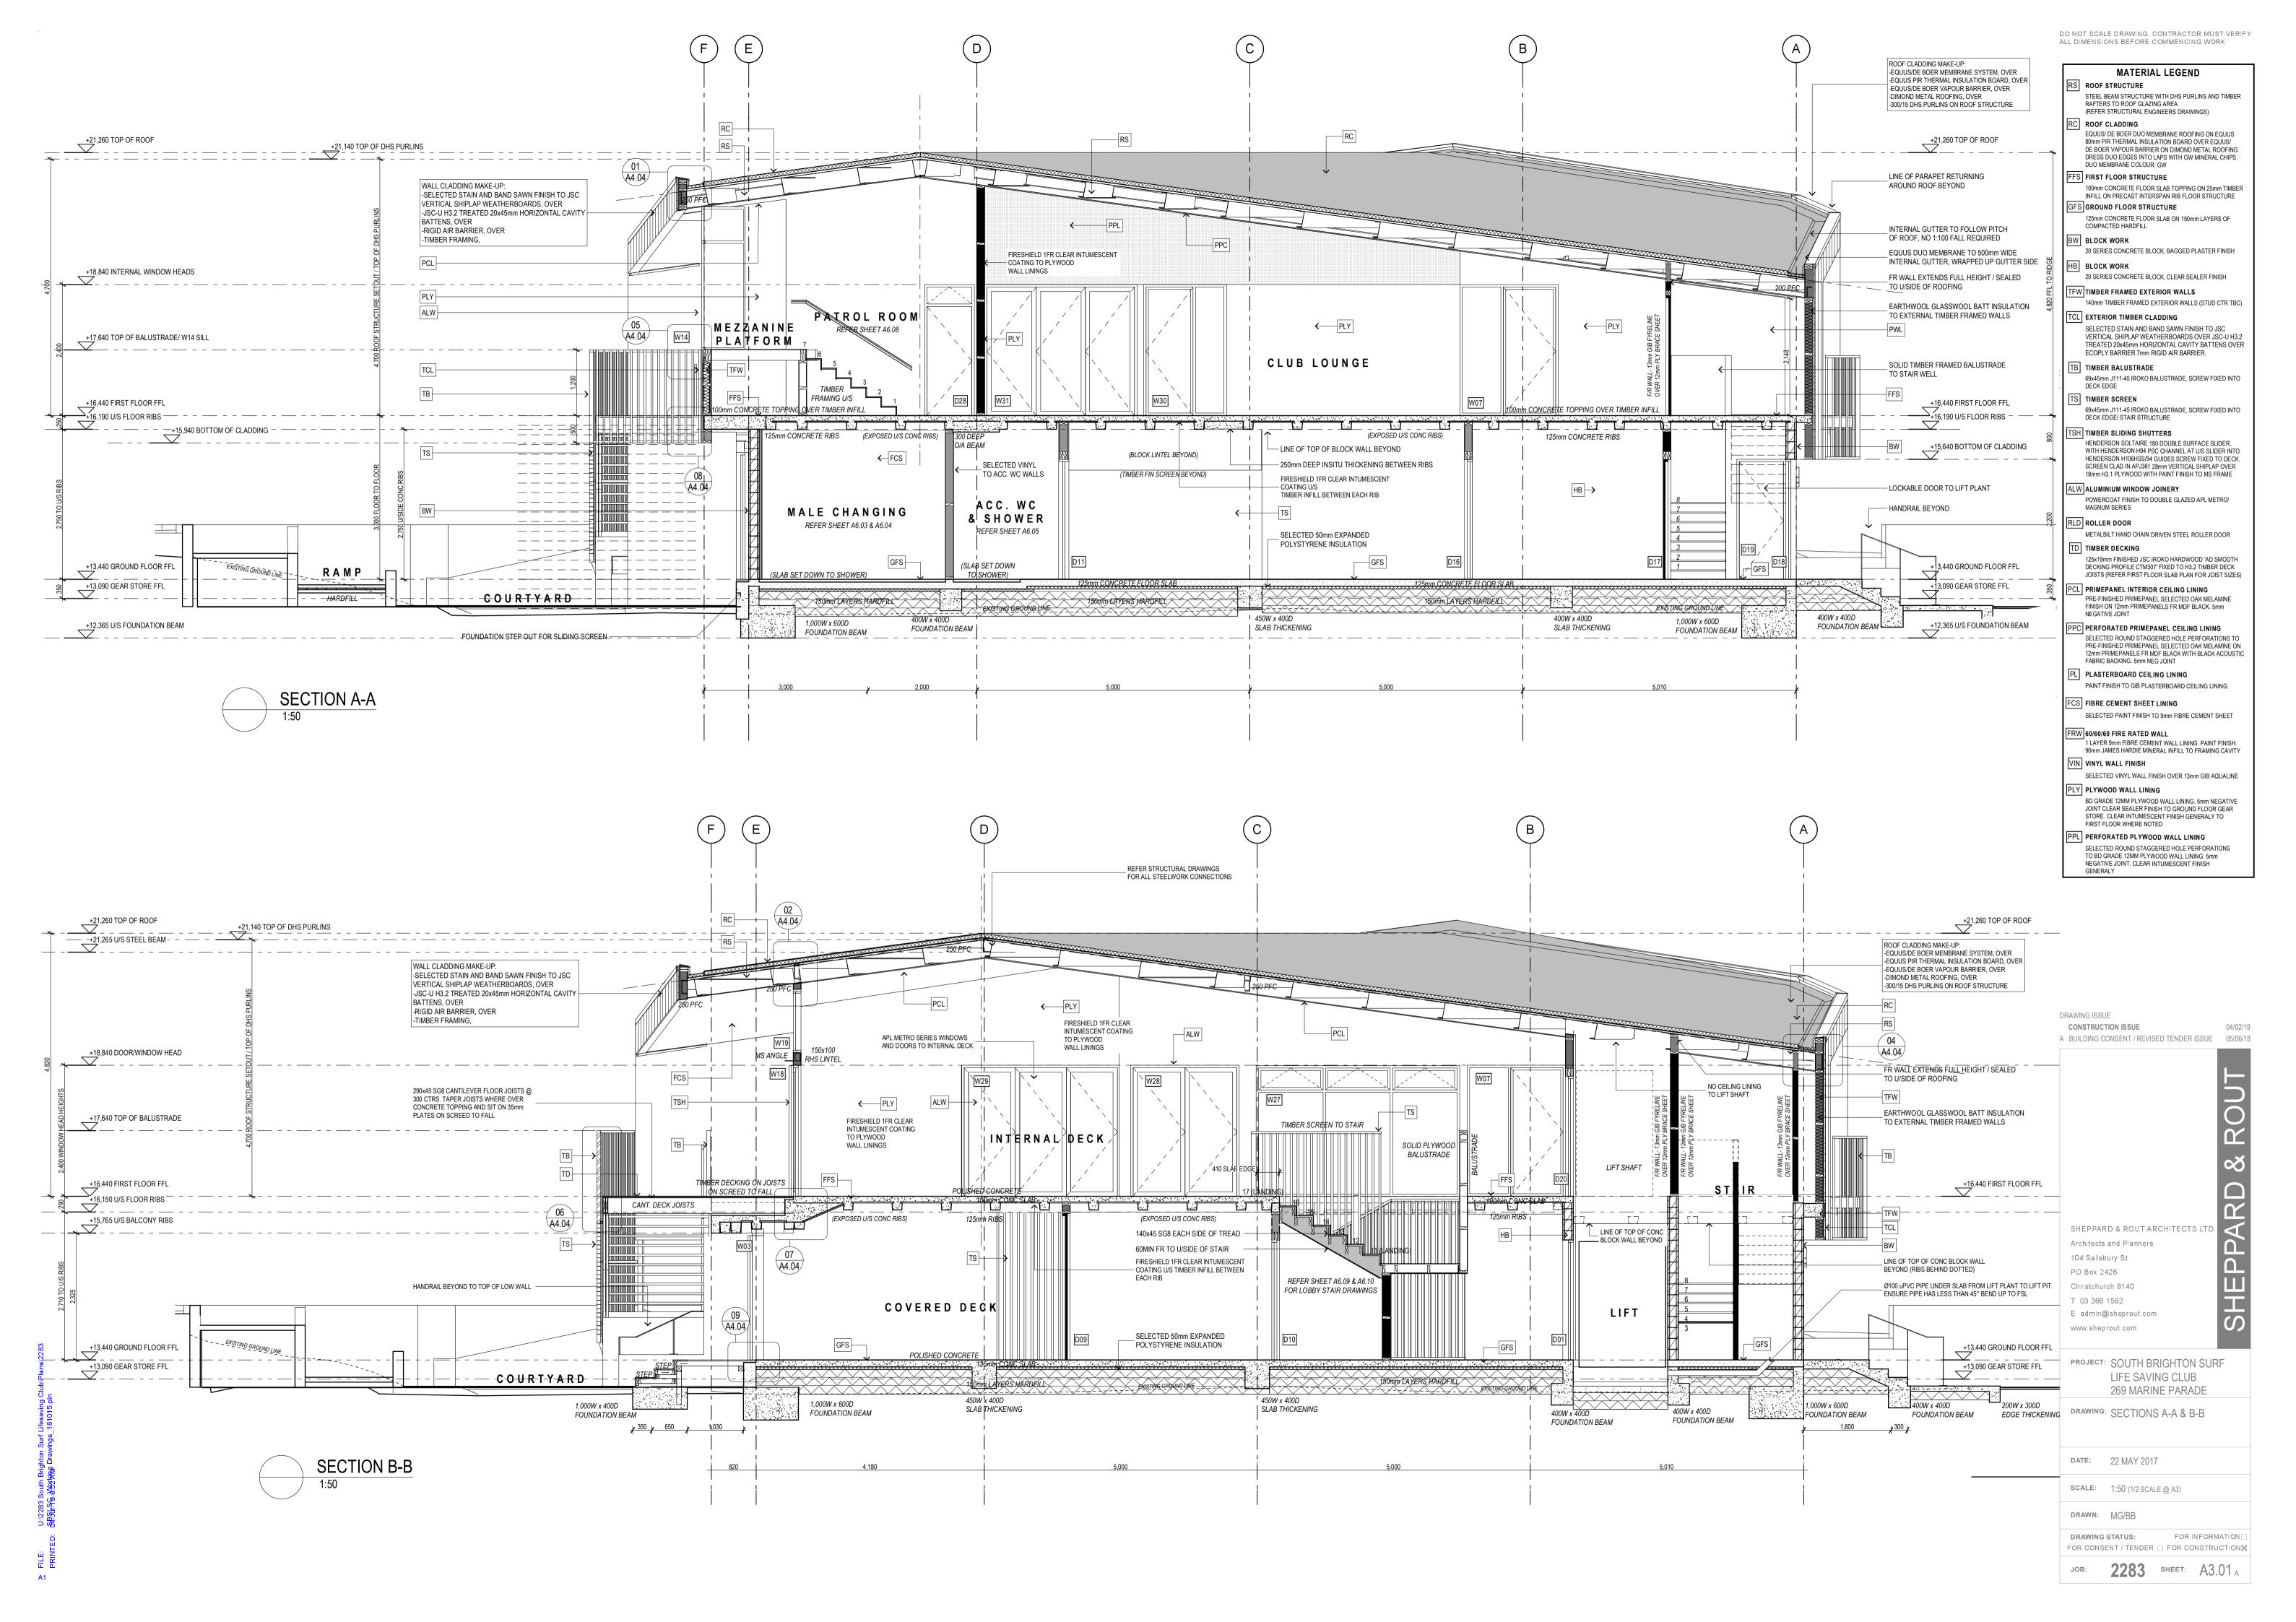

		RC ROOF CLADDING EQUUS/ DE BOER DUO MEMBRANE ROOFING ON EQUUS 80mm PIR THERMAL INSULATION BOARD OVER EQUUS/ DE BOER VAPOUR BARRIER ON DIMOND METAL ROOFING. DRESS DUO EDGES INTO LAPS WITH GW MINERAL CHIPS. DUO MEMBRANE COLOUR: GW
	+21,260 TOP OF ROOF	FFS FIRST FLOOR STRUCTURE 100mm CONCRETE FLOOR SLAB TOPPING ON 25mm TIMBER INFILL ON PRECAST INTERSPAN RIB FLOOR STRUCTURE
		GFS GROUND FLOOR STRUCTURE 125mm CONCRETE FLOOR SLAB ON 150mm LAYERS OF COMPACTED HARDFILL
		BW BLOCK WORK 20 SERIES CONCRETE BLOCK, BAGGED PLASTER FINISH
		HB BLOCK WORK 20 SERIES CONCRETE BLOCK, CLEAR SEALER FINISH
		TFW TIMBER FRAMED EXTERIOR WALLS 140mm TIMBER FRAMED EXTERIOR WALLS (STUD CTR TBC)
		TCL EXTERIOR TIMBER CLADDING SELECTED STAIN AND BAND SAWN FINISH TO JSC VERTICAL SHIPLAP WEATHERBOARDS OVER JSC-U H3.2 TREATED 20x45mm HORIZONTAL CAVITY BATTENS OVER ECOPLY BARRIER 7mm RIGID AIR BARRIER.
	+17,640 TOP OF BALUSTRADE	TB TIMBER BALUSTRADE 69x45mm J111-45 IROKO BALUSTRADE, SCREW FIXED INTO DECK EDGE TS TIMBER SCREEN
		69x45mm J111-45 IROKO BALUSTRADE, SCREW FIXED INTO DECK EDGE/ STAIR STRUCTURE
		TSH TIMBER SLIDING SHUTTERS HENDERSON SOLTAIRE 180 DOUBLE SURFACE SLIDER, WITH HENDERSON H94 PSC CHANNEL AT U/S SLIDER INTO
· · · · · · · · ·	+16,440 FIRST FLOOR FFL +16,115 U/S FLOOR RIBS	HENDERSON H106HSS/94 GUIDES SCREW FIXED TO DECK. SCREEN CLAD IN APJ361 28mm VERTICAL SHIPLAP OVER 18mm H3.1 PLYWOOD WITH PAINT FINISH TO MS FRAME
· · · · · · ·	→+15,865 U/S RIBS @ DECK	POWERCOAT FINISH TO DOUBLE GLAZED APL METRO/ MAGNUM SERIES
	R	RLD ROLLER DOOR METALBILT HAND CHAIN DRIVEN STEEL ROLLER DOOR TD TIMBER DECKING
	FLOOR	125x19mm FINISHED JSC IROKO HARDWOOD 'AD SMOOTH DECKING PROFILE CTM307' FIXED TO H3.2 TIMBER DECK JOISTS (REFER FIRST FLOOR SLAB PLAN FOR JOIST SIZES)
	LAWN S Ledus Harres - 000 Vick 16 August 16 Au	PCL PRIMEPANEL INTERIOR CEILING LINING PRE-FINISHED PRIMEPANEL SELECTED OAK MELAMINE FINISH ON 12mm PRIMEPANELS FR MDF BLACK. 5mm NEGATIVE JOINT
	+13,440 GROUND FLOOR FFL	PPC PERFORATED PRIMEPANEL CEILING LINING SELECTED ROUND STAGGERED HOLE PERFORATIONS TO PRE-FINISHED PRIMEPANEL SELECTED OAK MELAMINE ON
		12mm PRIMEPANELS FR MDF BLACK WITH BLACK ACOUSTIC FABRIC BACKING. 5mm NEG JOINT PL PLASTERBOARD CEILING LINING
	+12,365 U/S FOUNDATION BEAMS	PAINT FINISH TO GIB PLASTERBOARD CEILING LINING FCS FIBRE CEMENT SHEET LINING
		SELECTED PAINT FINISH TO 9mm FIBRE CEMENT SHEET
		1 LAYER 9mm FIBRE CEMENT WALL LINING. PAINT FINISH. 90mm JAMES HARDIE MINERAL INFILL TO FRAMING CAVITY VIN VINYL WALL FINISH
		SELECTED VINYL WALL FINISH OVER 13mm GIB AQUALINE PLY PLYWOOD WALL LINING
		BD GRADE 12MM PLYWOOD WALL LINING. 5mm NEGATIVE JOINT CLEAR SEALER FINISH TO GROUND FLOOR GEAR STORE. CLEAR INTUMESCENT FINISH GENERALY TO FIRST FLOOR WHERE NOTED
		PPL PERFORATED PLYWOOD WALL LINING SELECTED ROUND STAGGERED HOLE PERFORATIONS TO BD GRADE 12MM PLYWOOD WALL LINING. 5mm NEGATIVE JOINT. CLEAR INTUMESCENT FINISH
		GENERALY
RC		
RS	+21,260 TOP OF ROOF	
_		
WALL CLADDING MAKE-UP: -SELECTED STAIN AND BAND SAWN FINISH TO JSC VERTICAL SHIPLAP WEATHERBOARDS, OVER -JSC-U H3.2 TREATED 20x45mm HORIZONTAL CAVITY BATTENS, OVER -RIGID AIR BARRIER, OVER -TIMBER FRAMING,		DRAWING ISSUE CONSTRUCTION ISSUE 04/02/19 A BUILDING CONSENT / REVISED TENDER ISSUE 05/06/18
TCL		5
TFW		ROU
EARTHWOOL GLASSWOOL BATT INSULATION TO EXTERNAL TIMBER FRAMED WALLS		S S S S S S S S S S S S S S S S S S S
FFS	+16,440 FIRST FLOOR FFL	
	+16,115 FIRST FLOOR FFL	SHEPPARD & ROUT ARCHITECTS LTD Architects and Planners
		104 Salisbury St
	<u> </u>	Christchurch 8140
RLD		T 03 366 1562 E admin@sheprout.com www.sheprout.com
-GFS - SLAB REBATE AT ROLLER DOORS	+13,440 GROUND FLOOR FFL	project: SOUTH BRIGHTON SURF
	+13,440 GROUND FLOOR FFL +13,090 GEAR STORE FFL	LIFE SAVING CLUB 269 MARINE PARADE
	+12,365 U/S FOUNDATION BEAMS	drawing: SECTIONS C-C & D-D
		DATE: 22 MAY 2017
		scale: 1:50 (1/2 SCALE @ A3)
		drawn: MG/BB
		DRAWING STATUS: FOR INFORMATION

MATERIAL LEGEND

STEEL BEAM STRUCTURE WITH DHS PURLINS AND TIMBER

DRAWING STATUS: FOR INFORMATION FOR CONSENT / TENDER 🗌 FOR CONSTRUCTION


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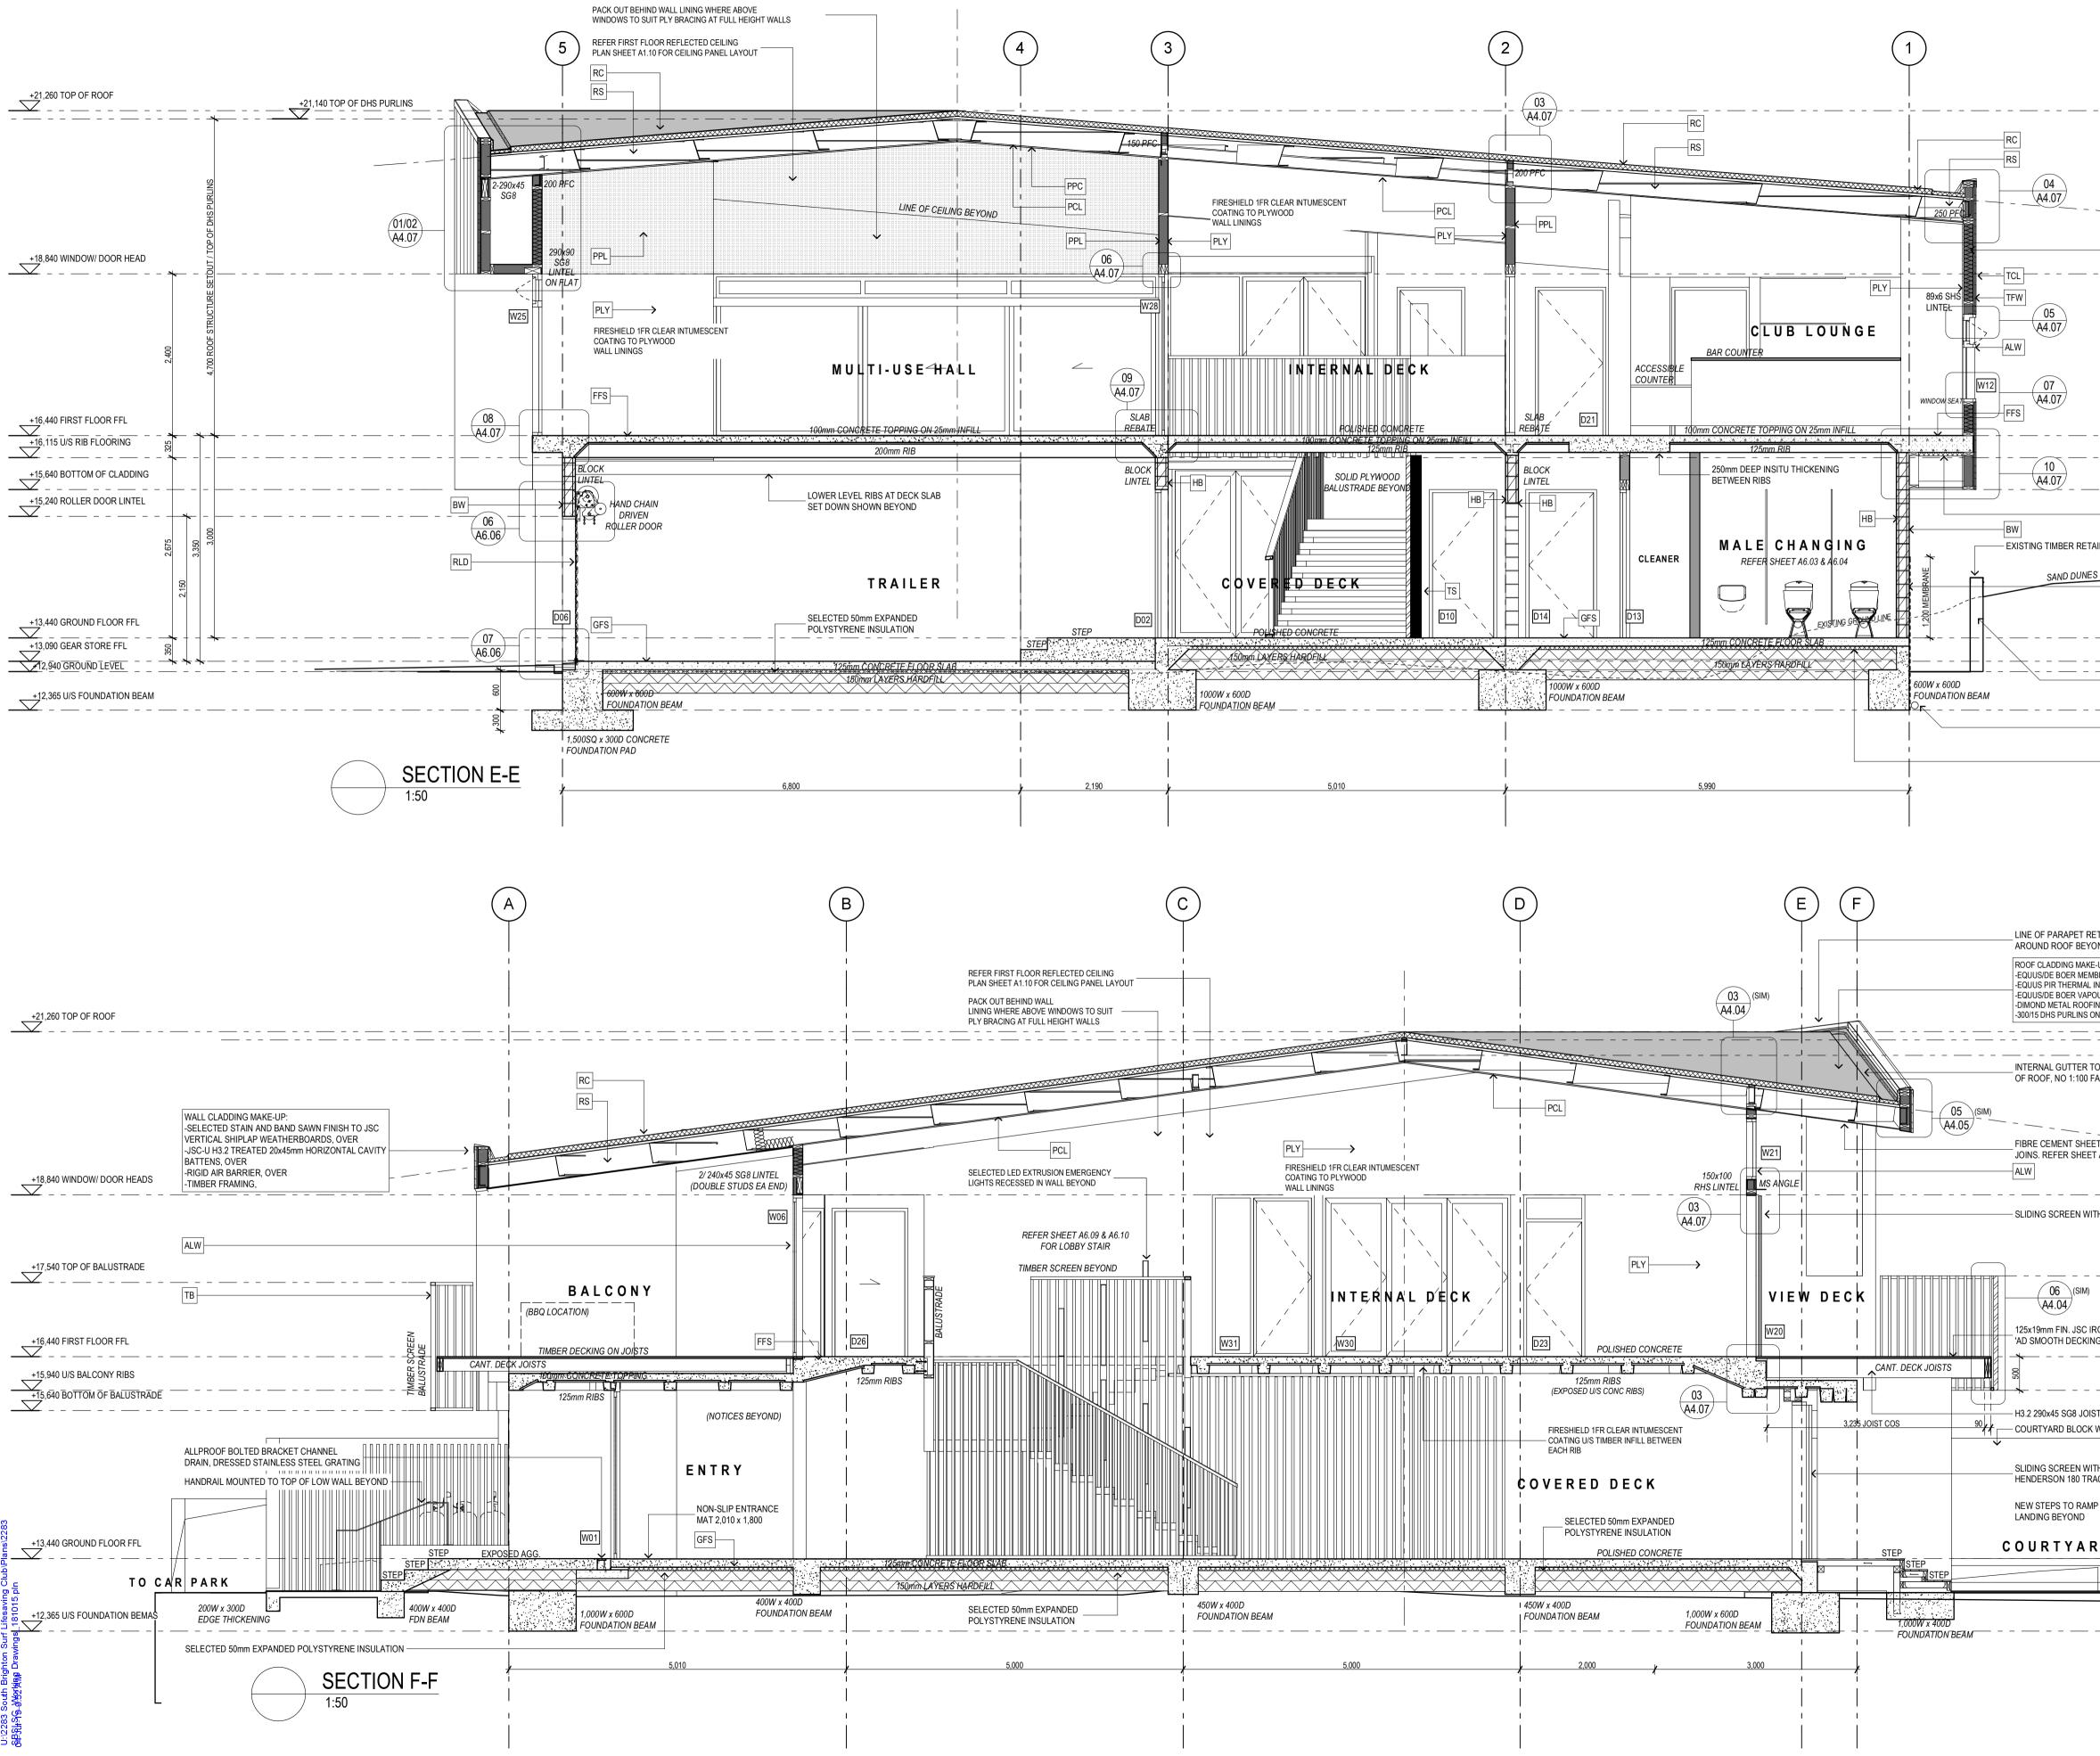
2283 SHEET: A3.02 A

RS ROOF STRUCTURE

ROOF CLADDING

RAFTERS TO ROOF GLAZING AREA (REFER STRUCTURAL ENGINEERS DRAWINGS)



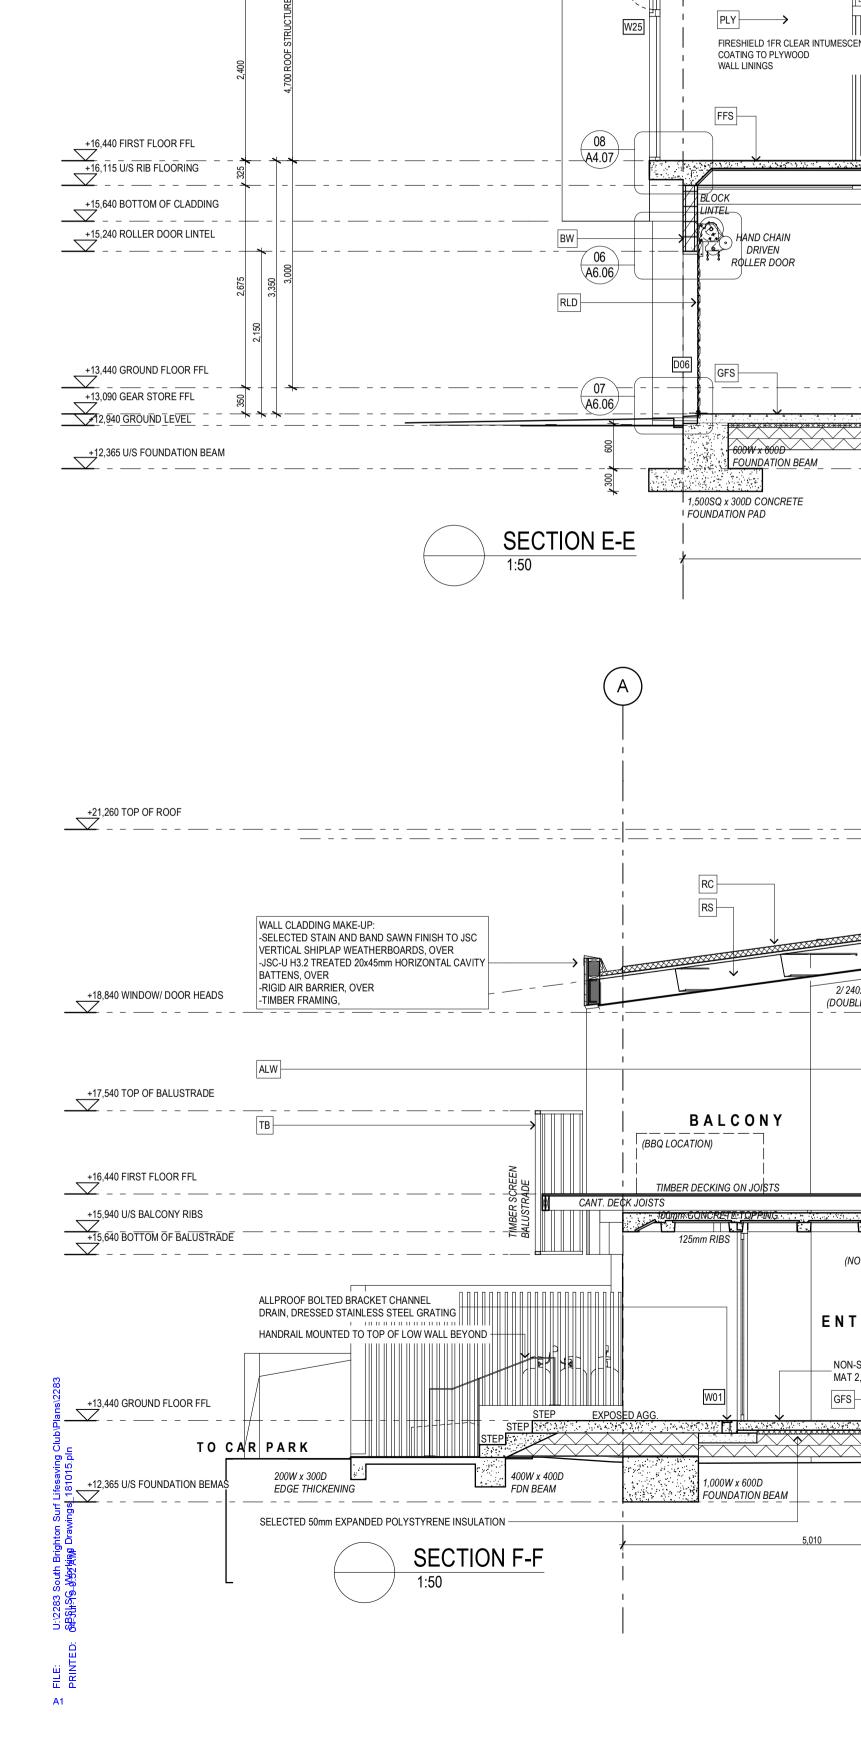

JOB:

2283 SHEET: A3.03 A

	The Dimensions before commensions work
	MATERIAL LEGEND RS ROOF STRUCTURE STEEL BEAM STRUCTURE WITH DHS PURLINS AND TIMBER RAFTERS TO ROOF GLAZING AREA (REFER STRUCTURAL ENGINEERS DRAWINGS) RC ROOF CLADDING EQUUS/ DE BOER DUO MEMBRANE ROOFING ON EQUUS 80mm PIR THERMAL INSULATION BOARD OVER EQUUS/
+21,260 TOP OF ROOF	DE BOER VAPOUR BARRIER ON DIMOND METAL ROOFING. DRESS DUO EDGES INTO LAPS WITH GW MINERAL CHIPS. DUO MEMBRANE COLOUR: GW FFS FIRST FLOOR STRUCTURE 100mm CONCRETE FLOOR SLAB TOPPING ON 25mm TIMBER INFILL ON PRECAST INTERSPAN RIB FLOOR STRUCTURE GFS GROUND FLOOR STRUCTURE
	125mm CONCRETE FLOOR SLAB ON 150mm LAYERS OF COMPACTED HARDFILL BW BLOCK WORK 20 SERIES CONCRETE BLOCK, BAGGED PLASTER FINISH HB BLOCK WORK
EARTHWOOL GLASSWOOL BATT INSULATION TO EXTERNAL TIMBER FRAMED WALLS	20 SERIES CONCRETE BLOCK, CLEAR SEALER FINISH TIMBER FRAMED EXTERIOR WALLS 140mm TIMBER FRAMED EXTERIOR WALLS (STUD CTR TBC) TCL EXTERIOR TIMBER CLADDING
	SELECTED STAIN AND BAND SAWN FINISH TO JSC VERTICAL SHIPLAP WEATHERBOARDS OVER JSC-U H3.2 TREATED 20x45mm HORIZONTAL CAVITY BATTENS OVER ECOPLY BARRIER 7mm RIGID AIR BARRIER. TIMBER BALUSTRADE
	69x45mm J111-45 IROKO BALUSTRADE, SCREW FIXED INTO DECK EDGE TS TIMBER SCREEN 69x45mm J111-45 IROKO BALUSTRADE, SCREW FIXED INTO DECK EDGE/ STAIR STRUCTURE
+16,440 FIRST FLOOR FFL +16,115 U/S RIB FLOORING	TSH TIMBER SLIDING SHUTTERS HENDERSON SOLTAIRE 180 DOUBLE SURFACE SLIDER, WITH HENDERSON H94 PSC CHANNEL AT U/S SLIDER INTO HENDERSON H106HSS/94 GUIDES SCREW FIXED TO DECK. SCREEN CLAD IN APJ361 28mm VERTICAL SHIPLAP OVER 18mm H3.1 PLYWOOD WITH PAINT FINISH TO MS FRAME
	ALW ALUMINIUM WINDOW JOINERY POWERCOAT FINISH TO DOUBLE GLAZED APL METRO/ MAGNUM SERIES RLD ROLLER DOOR
POLYSTYRENE INSULATION TO U/S CONCRETE SLAB IN LOCATIONS WHERE CANT SLAB IS ENCLOSED BY SOFFIT	METALBILT HAND CHAIN DRIVEN STEEL ROLLER DOOR TD TIMBER DECKING
ESEQUUS DE BOER DEBOBASE TANKING MEMBRANE APPLIED TO CONCRETE BLOCK WALL OVER DUO BITUMEN PRIMER WITH DANOSA DANODREN H15 PLUS HDPE DRAINAGE LAYER	125x19mm FINISHED JSC IROKO HARDWOOD 'AD SMOOTH DECKING PROFILE CTM307' FIXED TO H3.2 TIMBER DECK JOISTS (REFER FIRST FLOOR SLAB PLAN FOR JOIST SIZES) PCL PRIMEPANEL INTERIOR CEILING LINING PRE-FINISHED PRIMEPANEL SELECTED OAK MELAMINE FINISH ON 12mm PRIMEPANELS FR MDF BLACK. 5mm
+13,440 GROUND FLOOR FFL +13,090 GEAR STORE FFL 	NEGATIVE JOINT PPC PERFORATED PRIMEPANEL CEILING LINING SELECTED ROUND STAGGERED HOLE PERFORATIONS TO PRE-FINISHED PRIMEPANEL SELECTED OAK MELAMINE ON 12mm PRIMEPANELS FR MDF BLACK WITH BLACK ACOUSTIC FABRIC BACKING. 5mm NEG JOINT
+12,365 U/S FDN BEAMS	PL PLASTERBOARD CEILING LINING PAINT FINISH TO GIB PLASTERBOARD CEILING LINING
WATER TO SAND BENEATH. CAP OFF HIGH END SELECTED 50mm EXPANDED POLYSTYRENE INSULATION	FCS FIBRE CEMENT SHEET LINING SELECTED PAINT FINISH TO 9mm FIBRE CEMENT SHEET FRW 60/60/60 FIRE RATED WALL
	1 LAYER 9mm FIBRE CEMENT WALL LINING. PAINT FINISH. 90mm JAMES HARDIE MINERAL INFILL TO FRAMING CAVITY
RETURNING	SELECTED VINYL WALL FINISH OVER 13mm GIB AQUALINE PLY PLYWOOD WALL LINING BD GRADE 12MM PLYWOOD WALL LINING. 5mm NEGATIVE JOINT CLEAR SEALER FINISH TO GROUND FLOOR GEAR STORE. CLEAR INTUMESCENT FINISH GENERALY TO FIRST FLOOR WHERE NOTED PPL PERFORATED PLYWOOD WALL LINING SELECTED ROUND STAGGERED HOLE PERFORATIONS TO BD GRADE 12MM PLYWOOD WALL LINING. 5mm NEGATIVE JOINT. CLEAR INTUMESCENT FINISH
YOND KE-UP: MBRANE SYSTEM, OVER	GENERALY
L INSULATION BOARD, OVER POUR BARRIER, OVER IFING, OVER ON ROOF STRUCTURE 	
TO FOLLOW PITCH FALL REQUIRED	
	DRAWING ISSUE CONSTRUCTION ISSUE A BUILDING CONSENT / REVISED TENDER ISSUE 05/06/18
	& ROUT
IROKO HARDWOOD ING PROFILE CTM309' 	RD
	SHEPPARD & ROUT ARCHITECTS LTD Architects and Planners 104 Salisbury St
K WALL BEYOND	PO Box 2426 Christchurch 8140
	E admin@sheprout.com www.sheprout.com
	PROJECT: SOUTH BRIGHTON SURF LIFE SAVING CLUB 269 MARINE PARADE
+12,365 U/S FOUNDATION BEMAS	drawing: SECTIONS E-E & F-F
-	DATE: 22 MAY 2017
	SCALE: 1:50 (1/2 SCALE @ A3) DRAWN: MG/BB
	DRAWN: MG/BB DRAWING STATUS: FOR INFORMATION FOR CONSENT / TENDER FOR CONSTRUCTION